PROPOSED TWO STOREY DWELLING WITH BASEMENT & POOL AT 50 CHASELING ST, GREENACRE


DRAWING LIST

	-
Sheet Number	Sheet Name
A00	COVER SHEET
A01.01	DEMOLITION PLAN
A01.02	SITE PLAN & ROOF PLAN, SITE ANALYSIS PLAN
A01.03	WASTE MANAGEMENT PLAN AND SEDIMENT & EROSION CONTROL PLAN
A01.04	LANDSCAPING PLAN
A01.05	SITE CALCULATIONS
A02	PROPOSED BASEMENT FLOOR PLAN
A03	PROPOSED GROUND FLOOR PLAN
A04	PROPOSED FIRST FLOOR PLAN
A05.01	ELEVATIONS - PART 1
A05.02	ELEVATIONS - PART 2
A06	SECTION 1, DRIVEWAY SECTION & POOL SECTION
A07	3D_BASEMENT FLOOR
A08	3D_GROUND FLOOR
A09	3D_FIRST FLOOR
A10	3D_MODEL
A11	3D_MODEL
A12	WINDOWS & DOORS SCHEDULE
A13	SCHEDULE OF MATERIALS& FINISHES
A14	STREETSCAPE VIEW & FRONT FENCE ELEVATION
A15.01	SHADOW DIAGRAM - 21ST JUN
A15.02	3 HOURS OF SUNLIGHT TO LIVING - 21ST JUN
A15.03	3 HOURS OF SUNLIGHT TO 50% POS - 20TH MAR
A16	BASIX REQUIREMENTS
A17.01	NOTIFICATION PLANS - PART 1
A17.02	NOTIFICATION PLANS - PART 2






SS: 4, LEVEL 1, 0 CHAPEL RD, BANKSTOWN	BASEMENT & POOL	JOB NUMBER: 22808	DWG NUMBER:	ORIGINAL SIZE: A3	48:57
0 CHAPEL RD, BANKSTOWN, 200 9 5556 M: 0422 606 228 ham@nemcodesign.com.au	50 CHASELING ST, GREENACRE LOT 75, DP 35156	DESIGNED BY: A.N.	DATE: 03.02.2023	\bigcirc	023 2:
	COVER SHEET	DRAWN BY: A.N.	SCALE: AS SHOWN	D	3/02/2

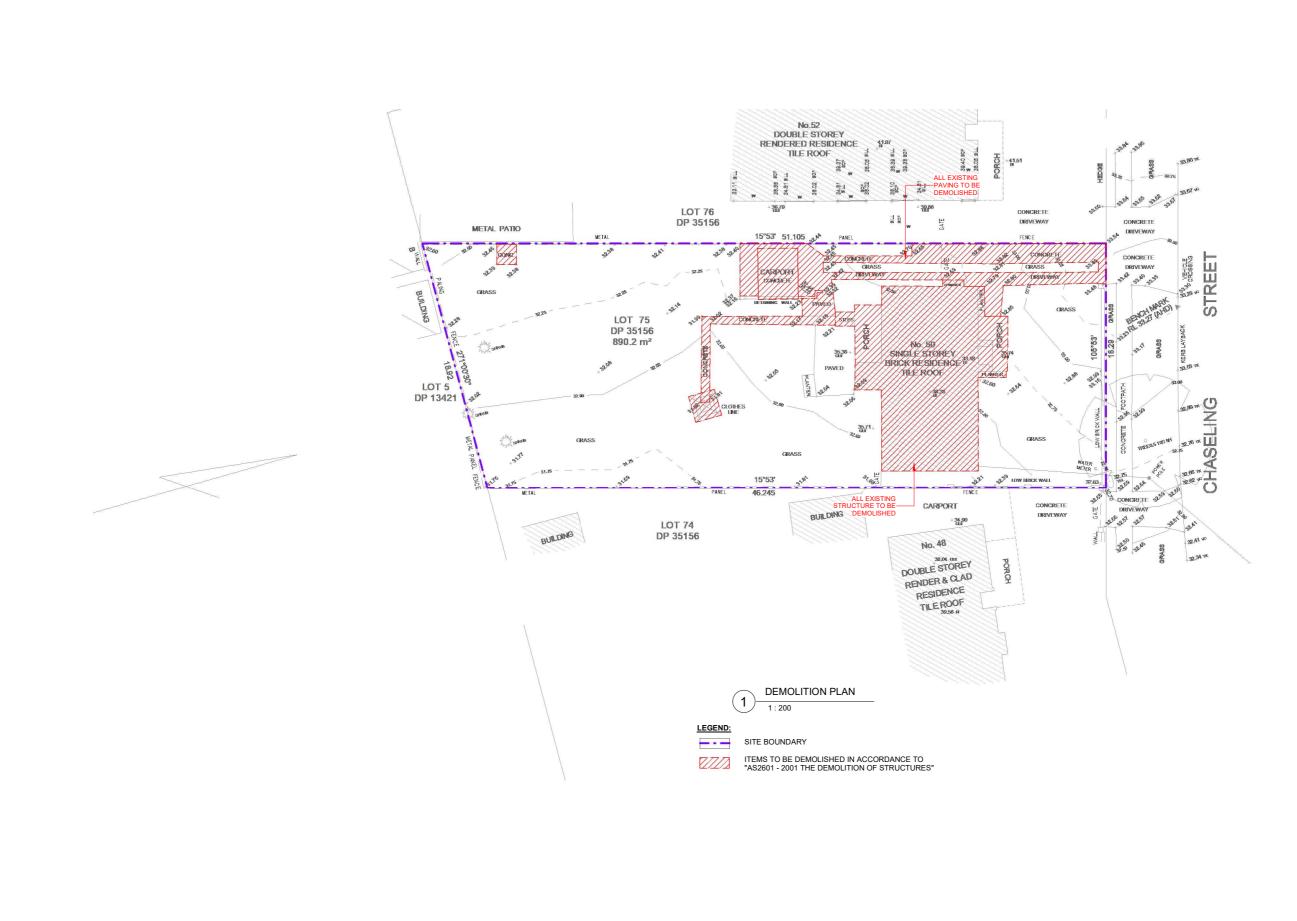




SS: 8, LEVEL 1, 9 CHAPEL RD. BANKSTOWN	PROPOSED TWO STOREY DWELLING WITH BASEMENT & POOL	22808	A01.01	A3
5556 M: 0422 606 228 ham@nemcodesign.com.au	50 CHASELING ST, GREENACRE LOT 75, DP 35156	DESIGNED BY: A.N.	DATE: 03.02.2023	\square
	DEMOLITION PLAN	DRAWN BY: A.N.	SCALE: AS SHOWN	KD

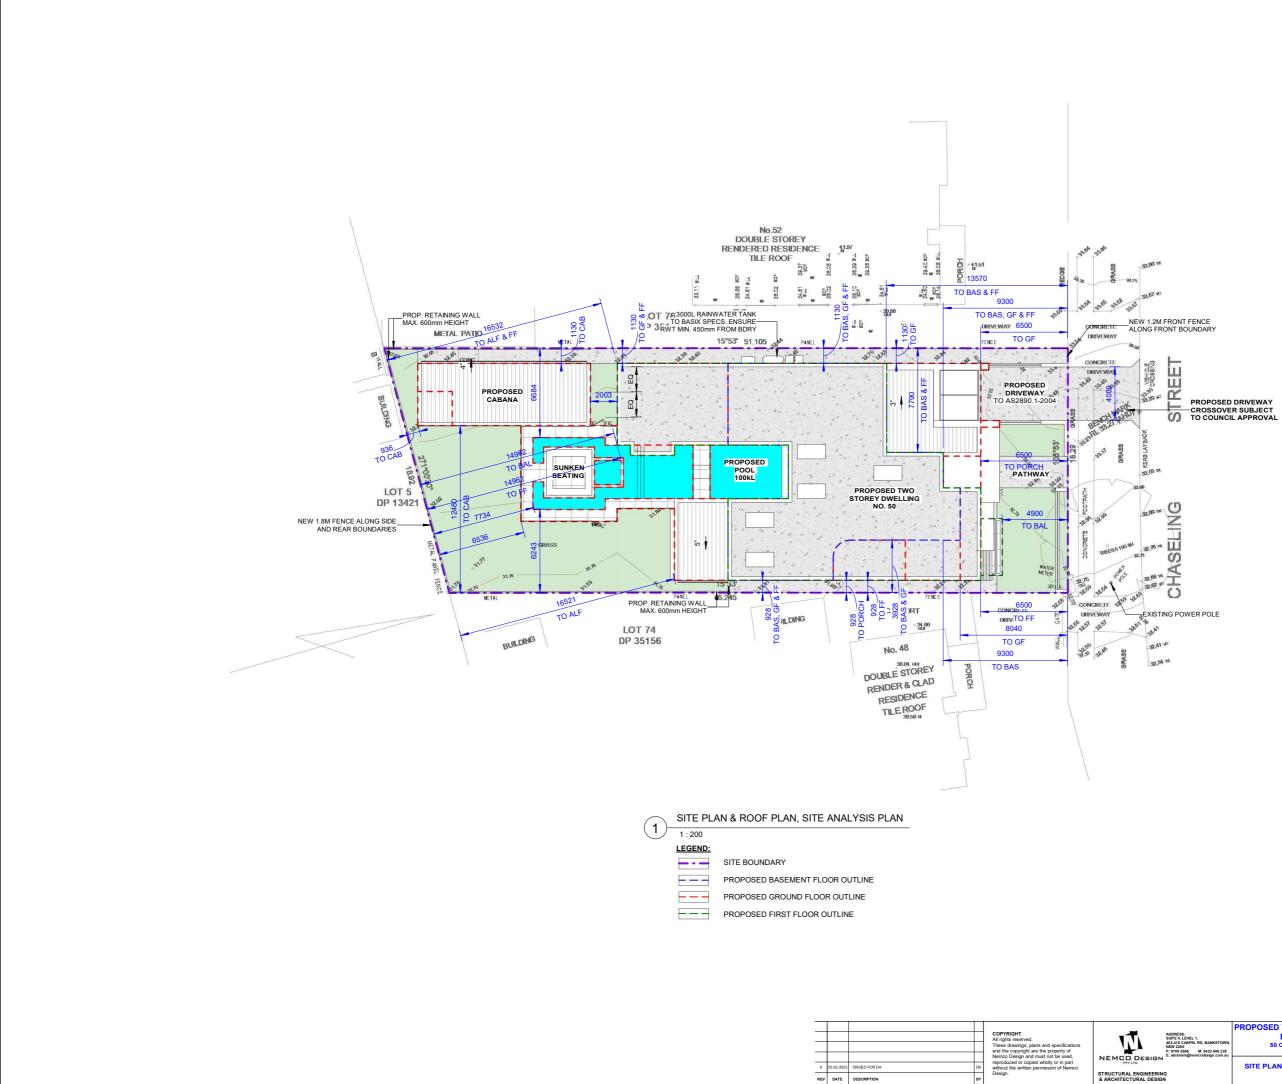

STRUCTURAL ENGINEERING & ARCHITECTURAL DESIGN


S: LEVEL 1, CHAPEL RD, BANKSTOWN	PROPOSED TWO STOREY DWELLING WITH BASEMENT & POOL	JOB NUMBER: 22808	A01.02	A3	
o 5556 M: 0422 606 228 am@nemcodesign.com.au	50 CHASELING ST, GREENACRE LOT 75, DP 35156	DESIGNED BY: A.N.	DATE: 03.02.2023		
	SITE PLAN & ROOF PLAN, SITE ANALYSIS PLAN	DRAWN BY: A.N.	SCALE: AS SHOWN	HD	

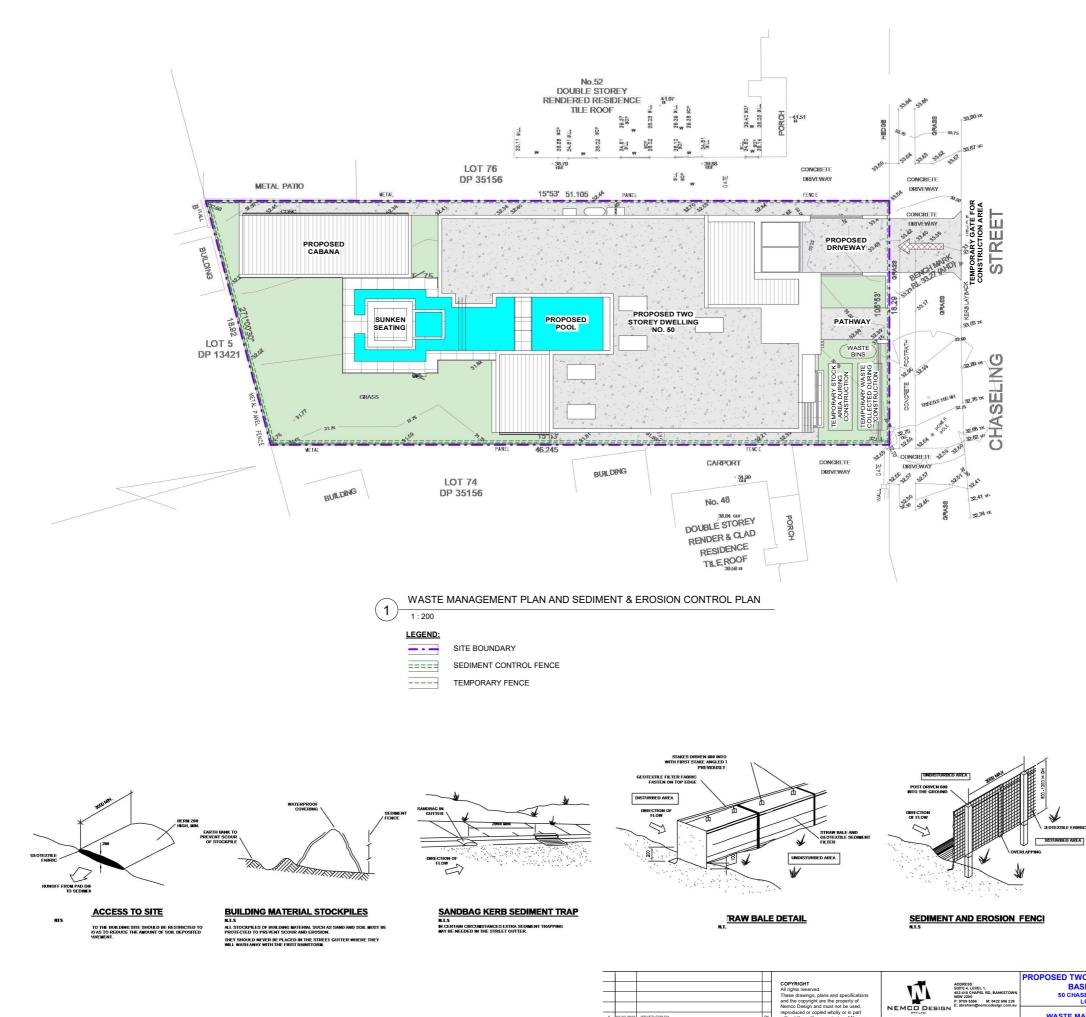

A 03.02.2023 REV DATE

STRUCTURAL ENGINEERING & ARCHITECTURAL DESIGN


	PROPOSED TWO STOREY DWELLING WITH	JOB NUMBER:	DWG NUMBER:	ORIGINAL SIZE:	2
S: LEVEL 1,	BASEMENT & POOL	22808	A01.03	A3	ė
CHAPEL RD, BANKSTOWN, 0 5556 M: 0422 606 228 am@nemcodesign.com.au	50 CHASELING ST, GREENACRE LOT 75, DP 35156	DESIGNED BY:	DATE: 03.02.2023		ċ
		A.N.	03.02.2023		ŝ
	WASTE MANAGEMENT PLAN AND SEDIMENT & EROSION CONTROL PLAN	DRAWN BY:	SCALE:		č
	SEDIMENT & EROSION CONTROL PLAN	A.N.	AS SHOWN	$ \mathcal{V} $	2

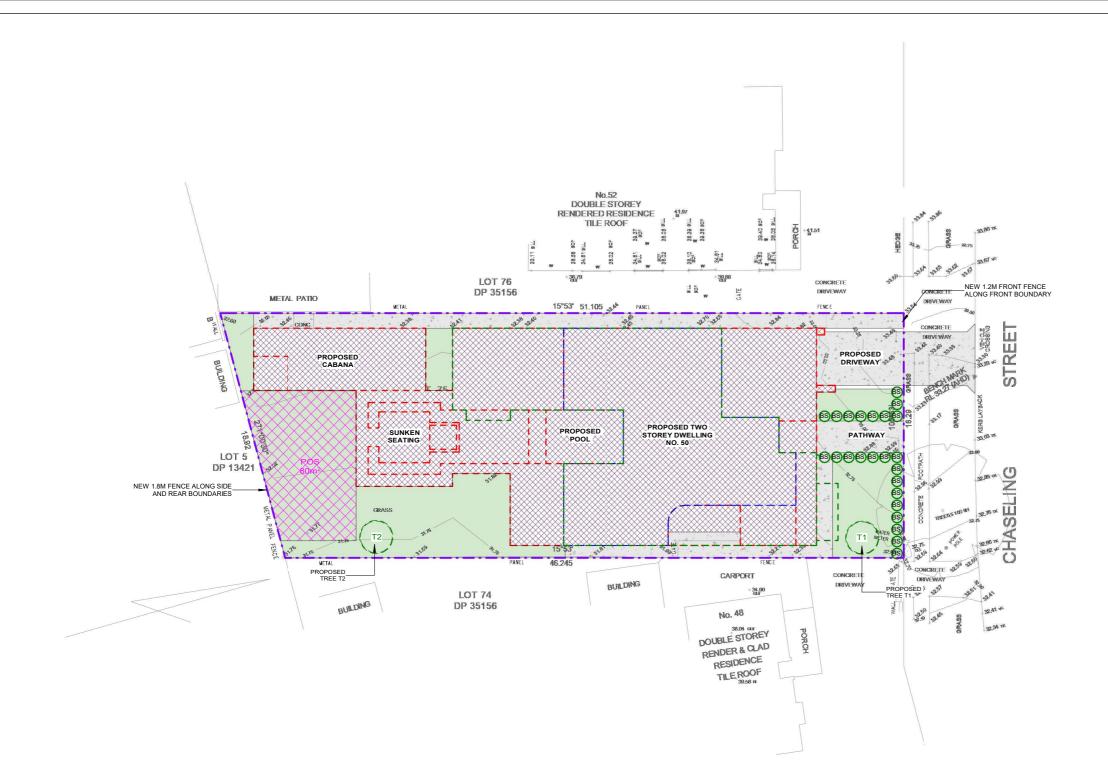

2. Minim	num soil st	andards f	or plant sizes a	re provided in	PL
accor	dance wit	h the Tabl	e below.		S١
Tree Size	Height	Spread	Min Soil Area	Min soil depth	
Large trees	>12m	>8m	10 x 10m	1200mm	

Large trees	>12m	>8m	10 x 10m	1200mm
Medium trees	8-12m	4-8m	6 x 6m	1000mm
Small trees	5-8m	<4m	3.5 x 3.5m	800mm
Shrubs	-	-	n/a	500-600mm
Groundcover	-	-	n/a	300-450mm
Turf	-	-	n/a	200mm

PLANTIN	G SCHEDULE			
SYMBOL	BOTANICAL NAME	COMMON NAME	MATURE SIZE	TYPE
BS	BURSARIA SPINOSA	BLACKTORN	1M	TREE
T1	ACACIA BINERVIA	MYALL WATTLE	5M	TREE

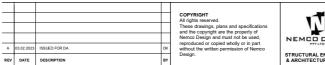



LEGEND:

SITE BOUNDARY

SITE BOUNDARY

PROPOSED DWELLING

PROPOSED DRIVEWAY &
CONCRETE AREAS

PROPOSED LANDSCAPING

POS 80m²

BS
PROPOSED SHRUB
Bursaria Spinosa (Blacktorn) 1m
T1-2
PROPOSED TREE
ADDUCTION (About Model)


-2 PROPOSED TREE ACACIA BINERVIA (Myall Wattle) 5m SIZE: MIN. 75 LTR


LANDSCAPING PLAN


1 : 200


(1)

5: LEVEL 1, CHAPEL RD. BANKSTOWN.	PROPOSED TWO STOREY DWELLING WITH BASEMENT & POOL	JOB NUMBER: 22808	A01.04	A3	
MAPEL RD, BANKSTOWN, 0 556 M: 0422 606 228 im@nemcodesign.com.au	50 CHASELING ST, GREENACRE LOT 75, DP 35156	DESIGNED BY: A.N.	DATE: 03.02.2023	\square	
	LANDSCAPING PLAN	DRAWN BY: A.N.	SCALE: AS SHOWN	KD	

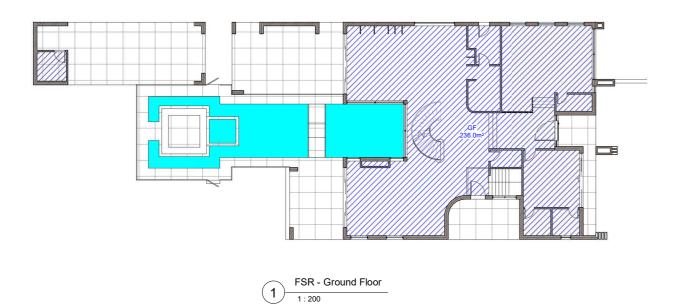


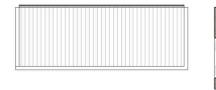

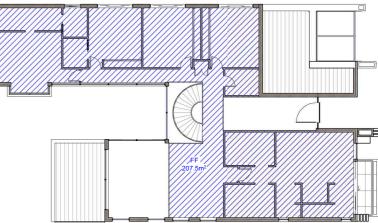

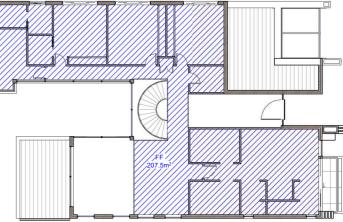


FSR - First Floor 2 FSR - F 1:200

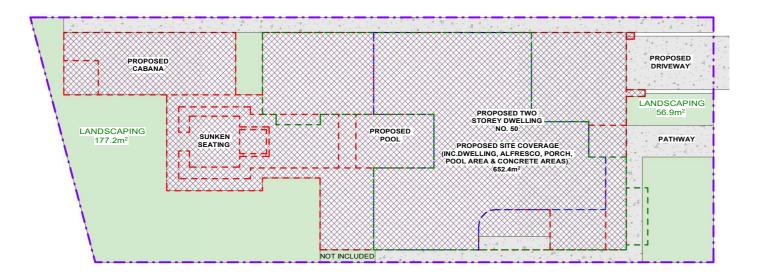


FLOOR AREA CALCULATIONS			
SITE AREA:	890.2m ²		
AREA OF THE PROPOSED GROUND FLOOR: AREA OF THE PROPOSED FIRST FLOOR:	236.0m ² 207.5m ²		
MAX. TOTAL FLOOR AREA	445.1m ²		
50% OF SITE AREA = 0.50 x 890.2m ² PROPOSED TOTAL FLOOR AREA:	443.5m ²	<	445.1m
SITE COVERAGE CALCULATIONS			
PROPOSED SITE COVERAGE: (INC. DWELLING, PORCH, ALFRESCO, POOL AREA & CONCRETE)	652.4m ²	(73	8.3%)
LANDSCAPING CALCULATIONS			
MIN. LANDSC. FORWARD OF BUILDING LINE: 45% OF THE AREA OF THE LOT FORWARD OF THE BUILDING LINE= 0.45 x 120.9m ²	54.4m ²		
PROPOSED LANDSCAPING AT FRONT:	56.9m ²	>	54.4m
PROPOSED LANDSCAPING AT REAR:	177.2m ²		
PROPOSED TOTAL LANDSCAPING AREA:	234.1m ²	(26	5.3%)




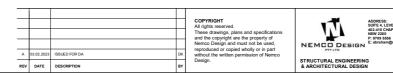

S: LEVEL 1, CHAPEL RD, BANKSTOWN,	PROPOSED TWO STOREY DWELLING WITH BASEMENT & POOL	JOB NUMBER: 22808	DWG NUMBER: A01.05	ORIGINAL SIZE: A3	
0 5556 M: 0422 606 228 am@nemcodesign.com.au	50 CHASELING ST, GREENACRE LOT 75, DP 35156	DESIGNED BY:	DATE: 03.02.2023	$\langle \rangle$	
	SITE CALCULATIONS	DRAWN BY: A.N.	SCALE: AS SHOWN	Ð	

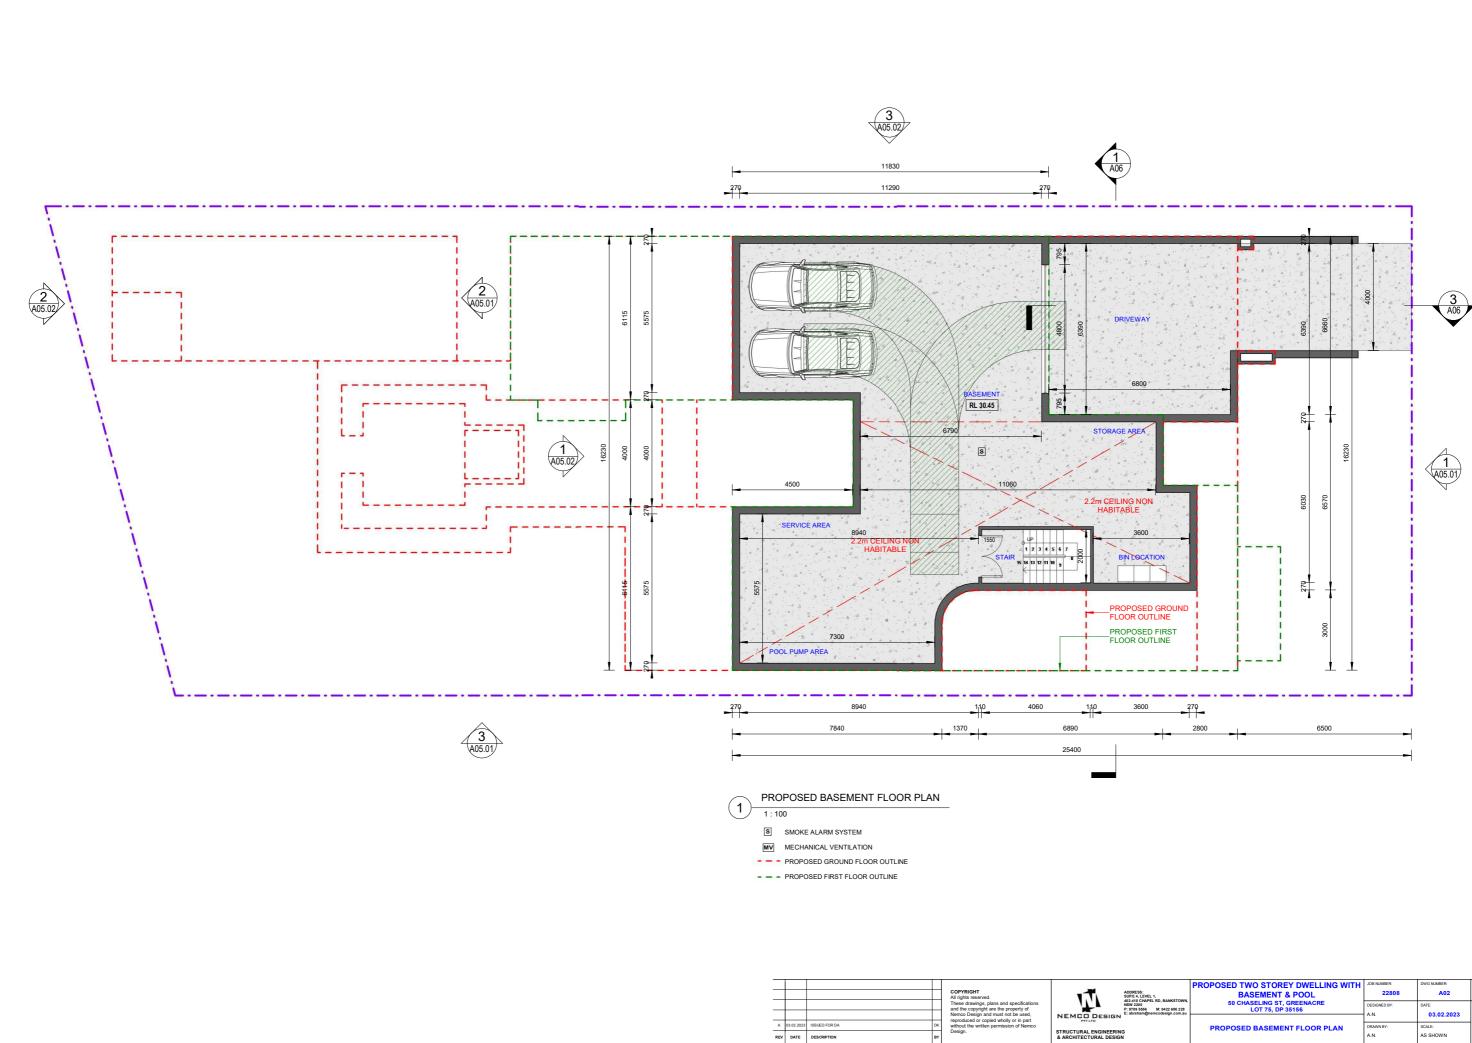

	PROPOSED TWO STOREY DWELLING WITH	JOB NUMBER:	DWG NUMBER:	ORIGINAL SIZE:	8
SS: 4, LEVEL 1,	BASEMENT & POOL	22808	A02	A3	- 8
0 CHAPEL RD, BANKSTOWN, 200 9 5556 M: 0422 606 228 ham@nemcodesign.com.au	50 CHASELING ST, GREENACRE LOT 75, DP 35156	DESIGNED BY:	DATE: 03.02.2023		35
in an		A.N.	03.02.2023	\square	202
	PROPOSED BASEMENT FLOOR PLAN	A.N.	AS SHOWN	Ľ)	3/02

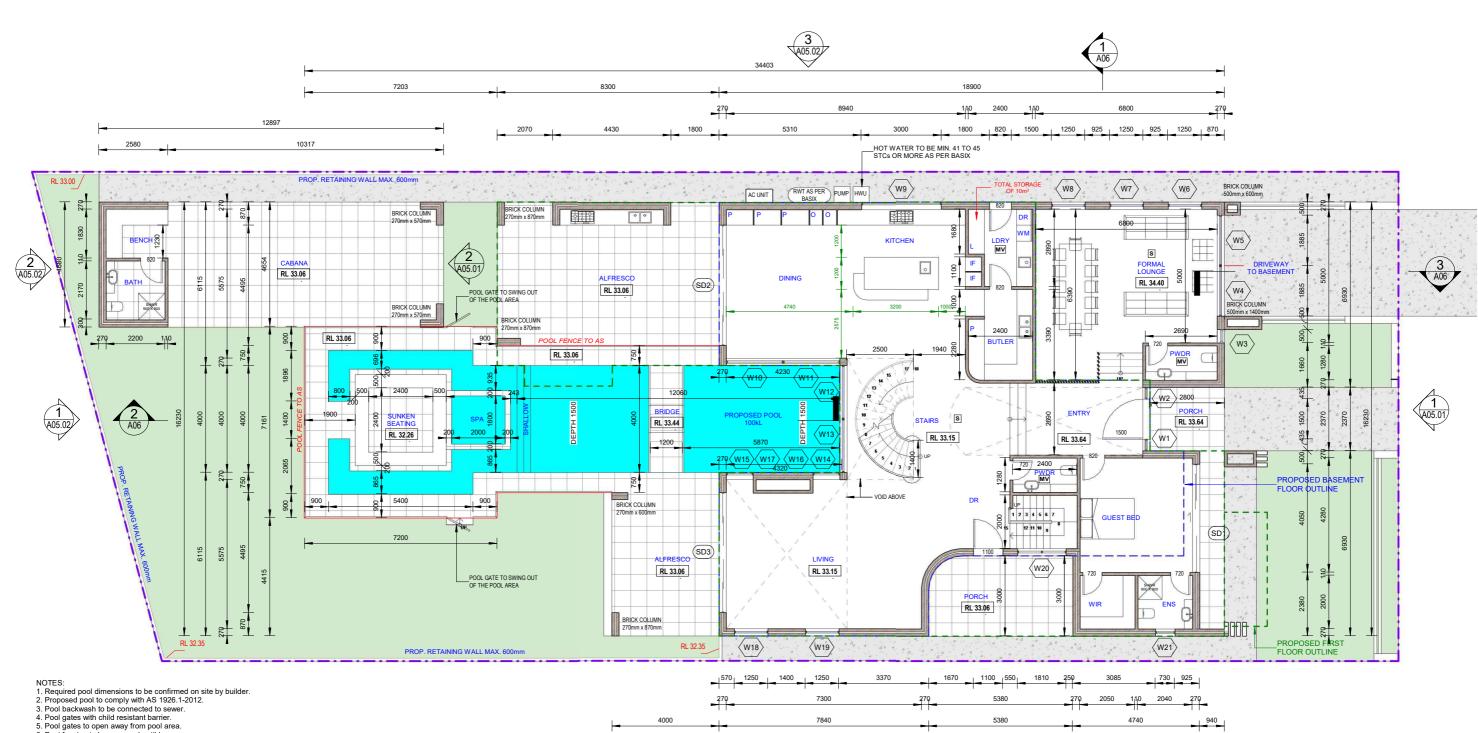


- Pool fencing to be non-combustible.
 Boundary fence (acting as pool barrier) to be min. 1.80m high from the level of pool decking. No footholds on the barrier.




(3 (A05.01)




				2
PROPOSED TWO STOREY DWELLING WITH	JOB NUMBER:	DWG NUMBER:	ORIGINAL SIZE:	8
BASEMENT & POOL	22808	A03	A3	8
50 CHASELING ST, GREENACRE LOT 75, DP 35156	DESIGNED BY:	DATE:	$\langle \rangle$	3 2:
	A.N.	03.02.2023		6
PROPOSED GROUND FLOOR PLAN	DRAWN BY: A.N.	SCALE: AS SHOWN	∇	3/02/2

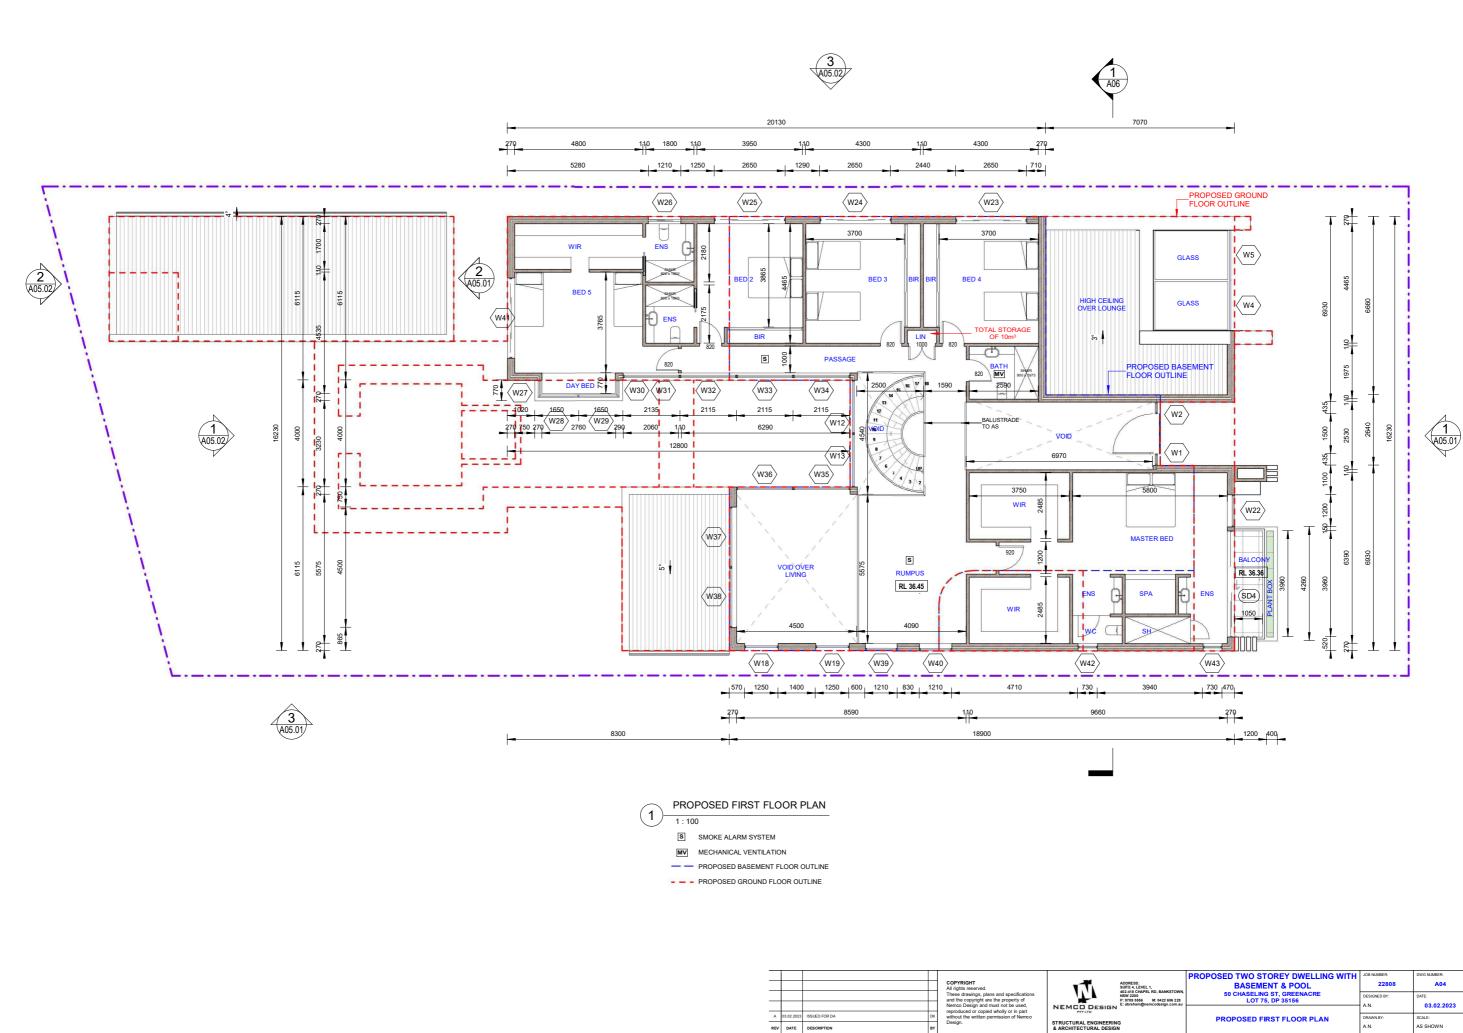

SS: I, LEVEL 1, J, CHAPEL RD, BANKSTOWN	PROPOSED TWO STOREY DWELLING WITH BASEMENT & POOL	JOB NUMBER: 22808	DWG NUMBER: A04	ORIGINAL SIZE: A3	
5556 M: 0422 606 228 ham@nemcodesign.com.au	50 CHASELING ST, GREENACRE LOT 75, DP 35156	DESIGNED BY: A.N.	DATE: 03.02.2023	\bigcirc	
	PROPOSED FIRST FLOOR PLAN	DRAWN BY: A.N.	SCALE: AS SHOWN	D	

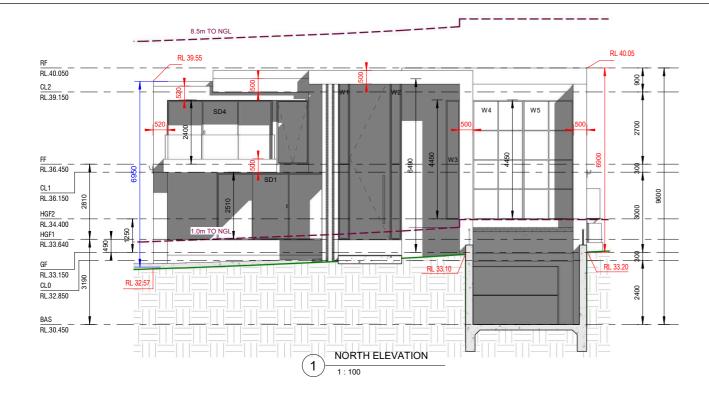

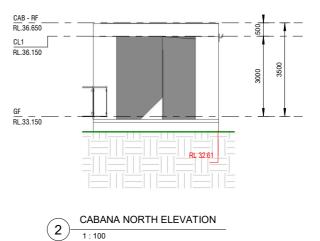







SS: 4, LEVEL 1, 0 CHAPEL RD, BANKSTOWN	PROPOSED TWO STOREY DWELLING WITH BASEMENT & POOL	JOB NUMBER: 22808	DWG NUMBER: A05.01	ORIGINAL SIZE: A3	49:06
0 CHAPEL RD, BANKSTOWN, 200 9 5556 M: 0422 606 228 ham@nemcodesign.com.au	50 CHASELING ST, GREENACRE LOT 75, DP 35156	DESIGNED BY: A.N.	DATE: 03.02.2023	\bigcirc	023 2:
	ELEVATIONS - PART 1	DRAWN BY: A.N.	SCALE: AS SHOWN	D	3/02/2




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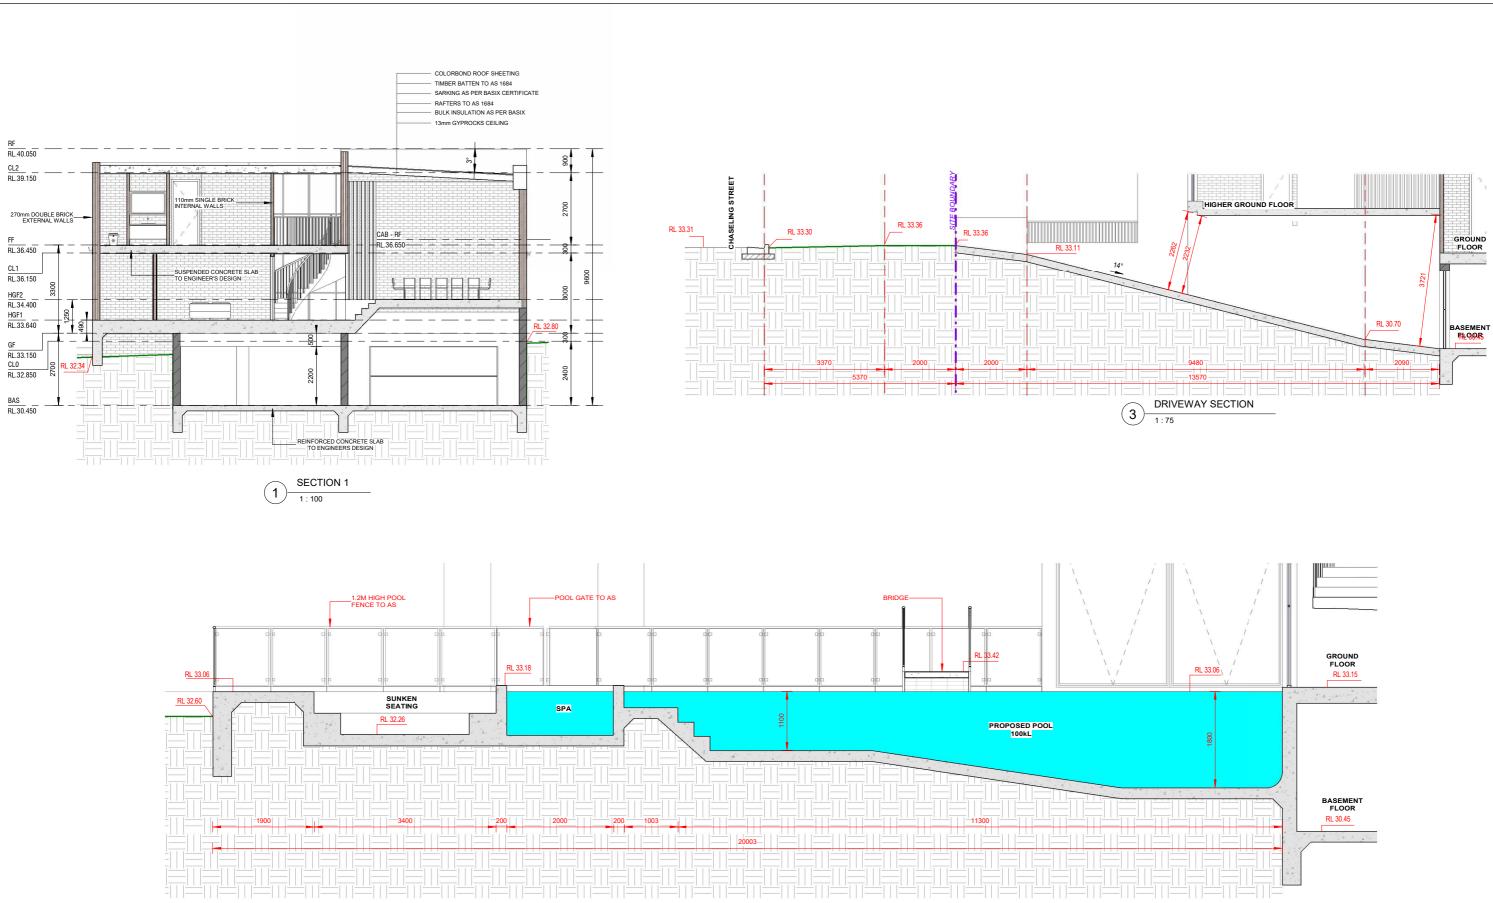


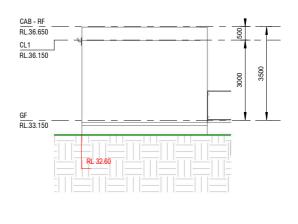
3 WEST ELEVATION 1:100

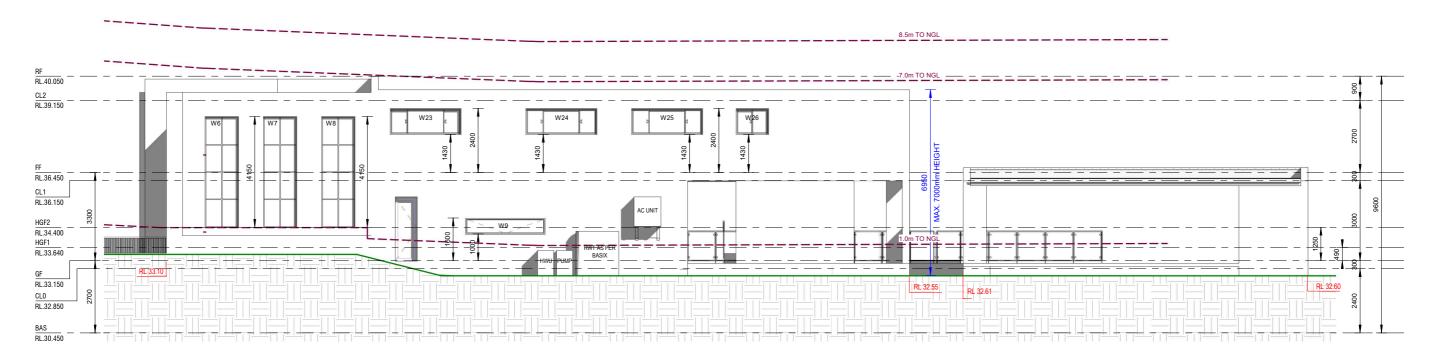


CABANA SOUTH ELEVATION


SS: . LEVEL 1, CHAPEL RD. BANKSTOWN.	PROPOSED TWO STOREY DWELLING WITH BASEMENT & POOL	JOB NUMBER: 22808	DWG NUMBER: A05.02	ORIGINAL SIZE: A3
00 5556 M: 0422 606 228 nam@nemcodesign.com.au	50 CHASELING ST, GREENACRE LOT 75, DP 35156	DESIGNED BY:	DATE: 03.02.2023	$\langle \rangle$
	ELEVATIONS - PART 2	DRAWN BY: A.N.	SCALE: AS SHOWN	(\mathcal{P})

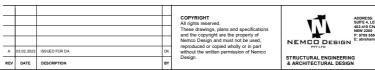

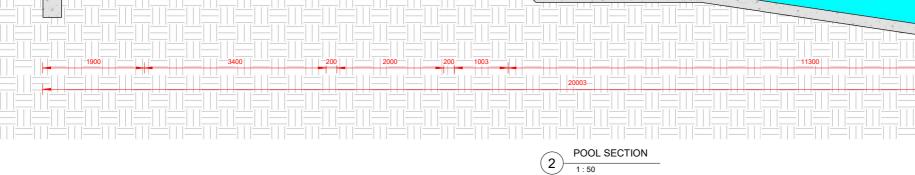


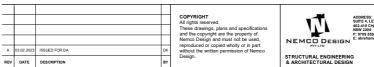


PROPOSED TWO STOREY DWELLING WITH	JOB NUMBER:	DWG NUMBER:	ORIGINAL SIZE:
BASEMENT & POOL	22808	A06	A3
LOT 75, DP 35156	DESIGNED BY:	DATE:	
SECTION 1, DRIVEWAY SECTION & POOL SECTION	A.N.	03.02.2023	
	DRAWN BY: A.N.	SCALE: AS SHOWN	KD
	BASEMENT & POOL 50 CHASELING ST, GREENACRE LOT 75, DP 35166 SECTION 1, DRIVEWAY SECTION & POOL	SECTION 1, DRIVEWAY SECTION & POOL SECTION 1, DRIVEWAY SECTION & POOL SECTION 1, DRIVEWAY SECTION & POOL SECTION 1, DRIVEWAY SECTION & POOL	PROPOSED TWO STORED DWELLING WITH BASEMENT & POOL 50 CHASELING ST, GREENACRE DESIGNED BY: DATE: LOT 75, DP 35156 A.N. 03.02.2023 SECTION 1, DRIVEWAY SECTION & POOL SECTION 1, DRIVEWAY SECTION & POOL DRIVINEY: SOLE:

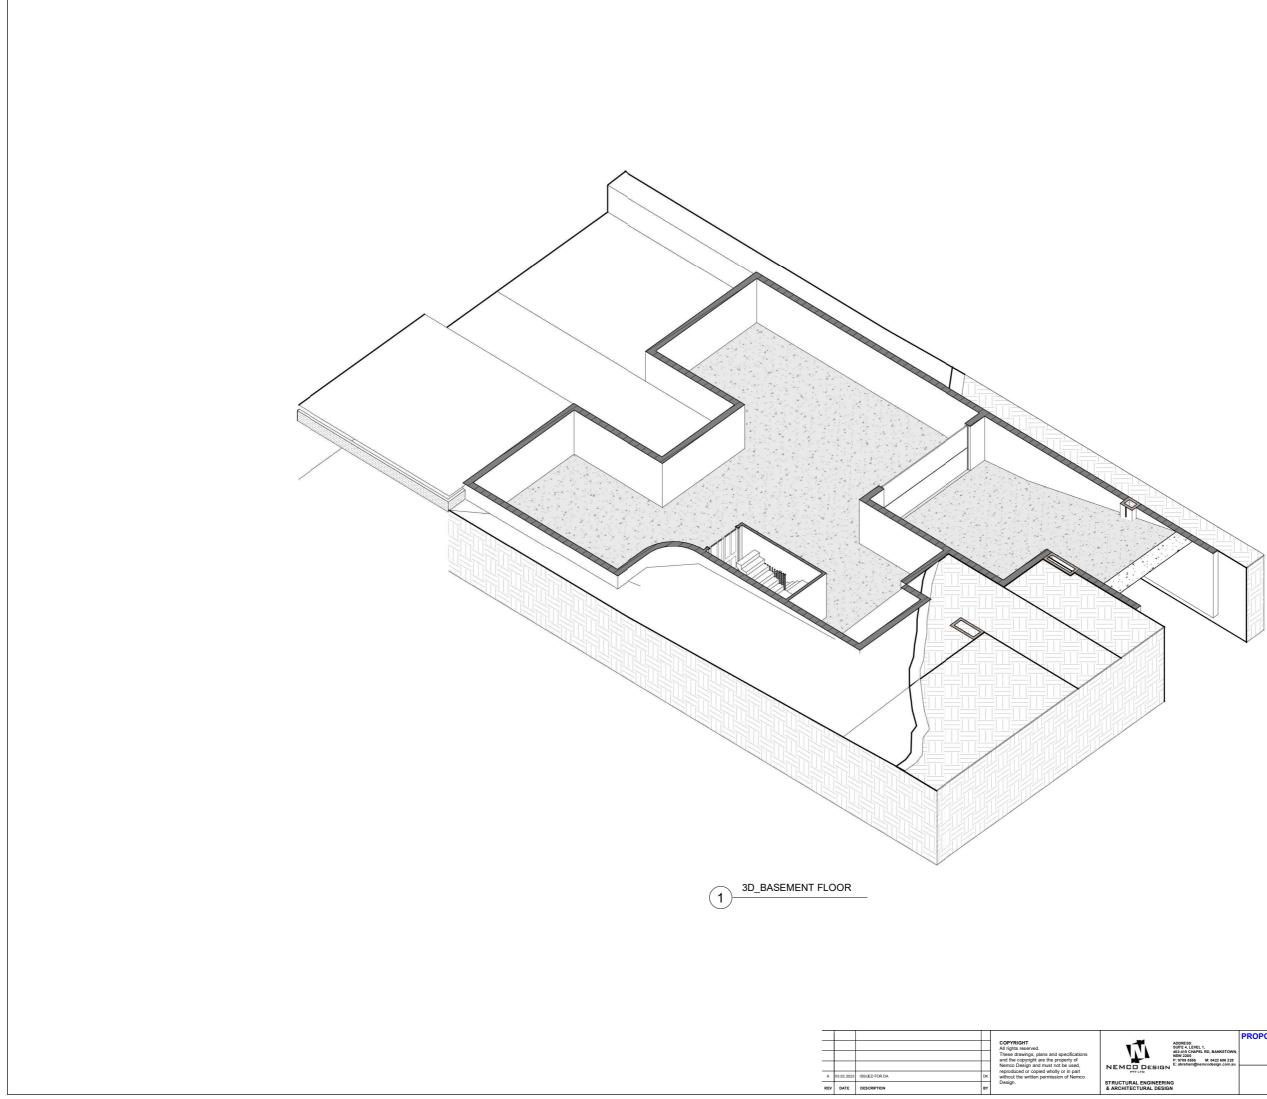


IS: LEVEL 1, CHAPEL RD, BANKSTOWN	PROPOSED TWO STOREY DWELLING WITH BASEMENT & POOL	JOB NUMBER: 22808	DWG NUMBER: A07	ORIGINAL SIZE: A3	
CHAPEL RD, BANKSTOWN, 00 5556 M: 0422 606 228 am@nemcodesign.com.au	50 CHASELING ST, GREENACRE LOT 75, DP 35156	DESIGNED BY: A.N.	DATE: 03.02.2023	$ \land $	
	3D_BASEMENT FLOOR	DRAWN BY: A.N.	SCALE: AS SHOWN	KD	

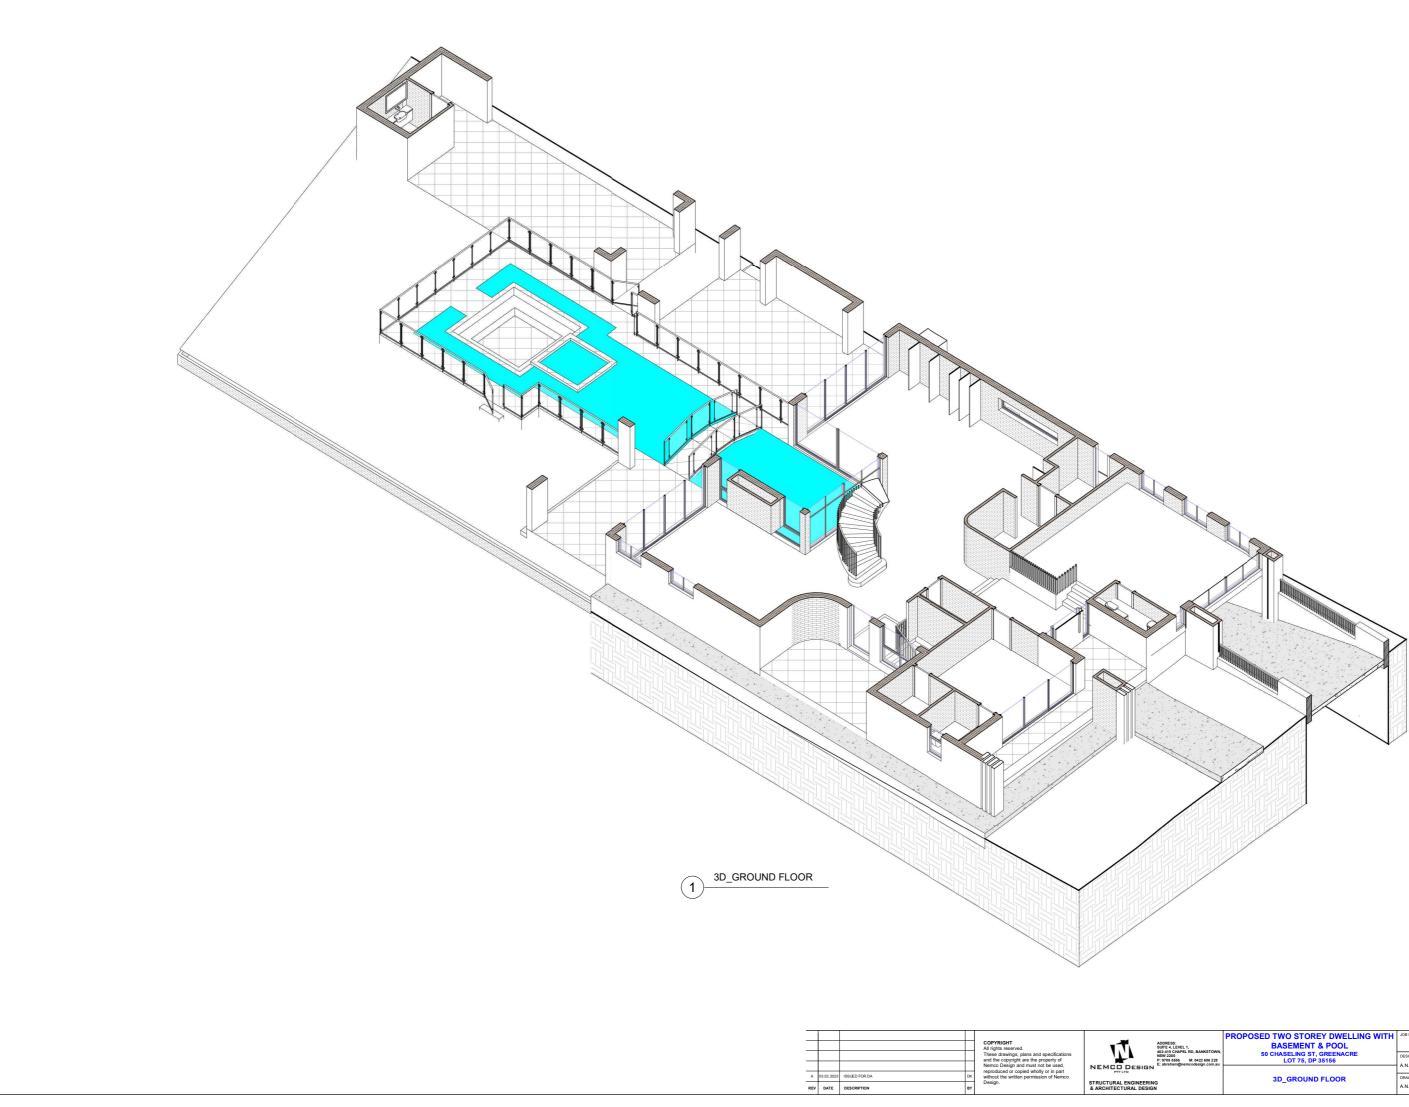

PROPOSED TWO STOREY DWELLING WITH	JOB NUMBER:	DWG NUMBER:	ORIGINAL SIZE:	1
BASEMENT & POOL	22808	A08	A3	1
50 CHASELING ST, GREENACRE LOT 75, DP 35156	DESIGNED BY:	DATE:		
	A.N.	03.02.2023		
3D_GROUND FLOOR	DRAWN BY:	SCALE:		1
_	A.N.	AS SHOWN	\searrow	
	BASEMENT & POOL 50 CHASELING ST, GREENACRE LOT 75, DP 35156	PROPOSED TWO STORET DWELLING WITH BASEMENT & POOL 50 CHASELING ST, GREENACRE DESIGNED BY: LOT 75, DP 35156 A.N. 3D_GROUND FLOOR DRWINBY:	PROPOSED TWO STORET DWELLING WITH BASEMENT & POOL 50 CHASELING ST, GREENACRE LOT 75, DP 35156 A08 3D_GROUND FLOOR DRSIGED BY: DATE: 3D_GROUND FLOOR DRWINEY: SOLE:	BASEMENT & POOL 22808 A08 A3 50 CHASELING ST, GREENACRE DESIGNED BY: DATE: AN. 03.02.2023 3D_GROUND FLOOR DAWN BY: SCILE DAWN BY: SCILE

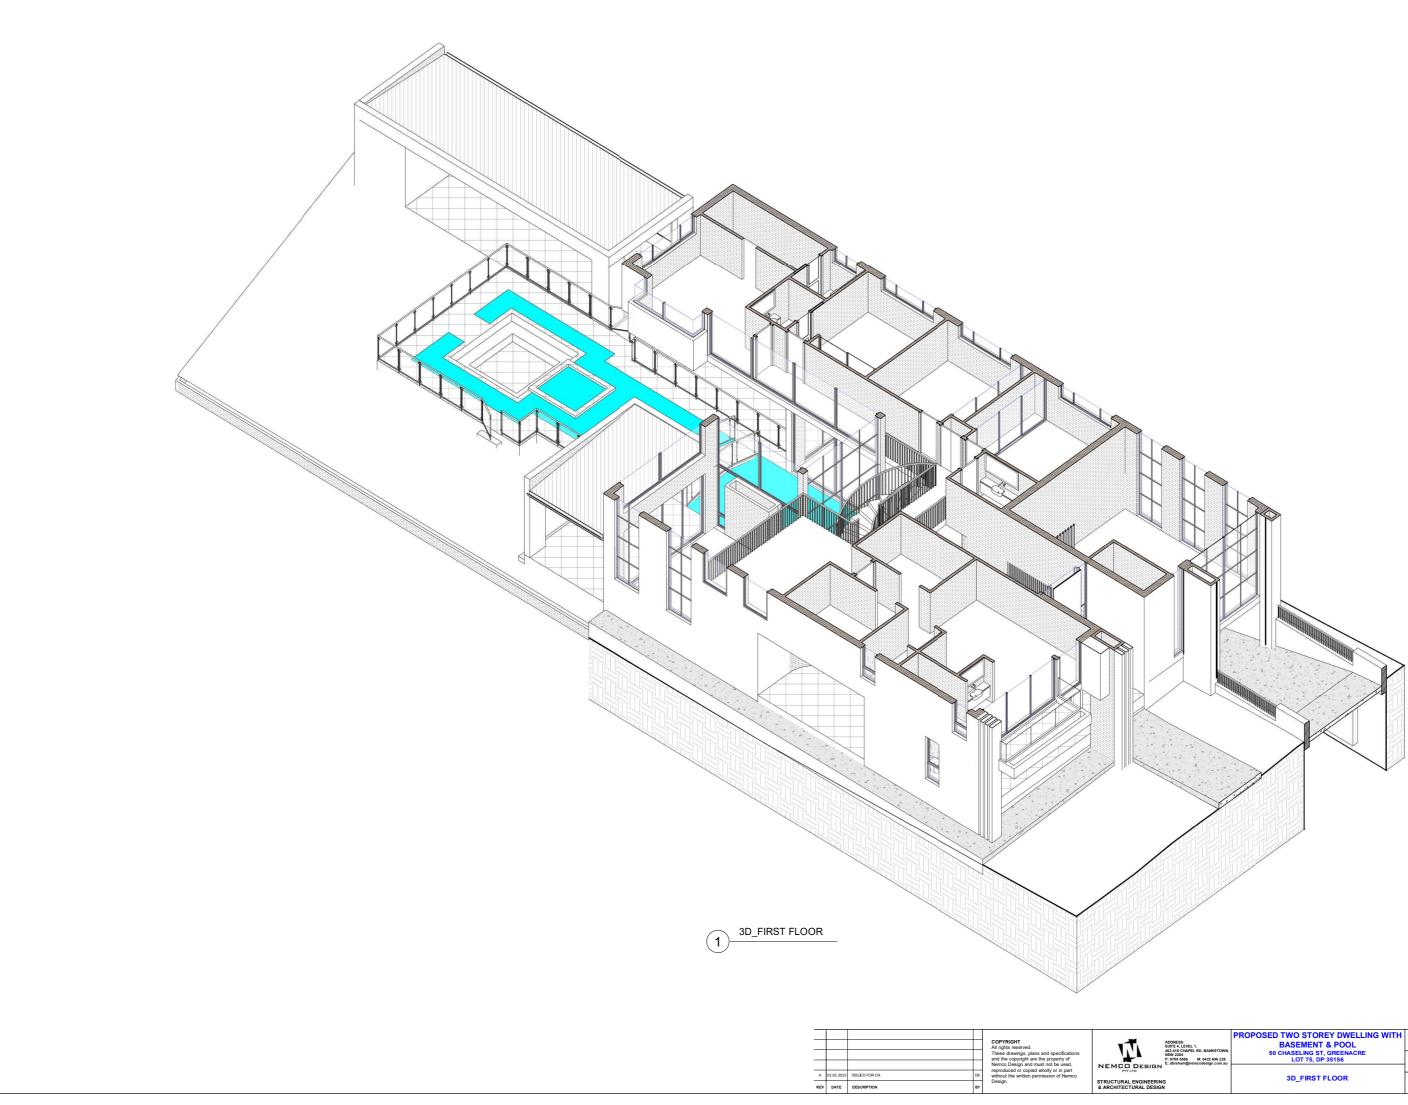


	PROPOSED TWO STOREY DWELLING WITH	JOB NUMBER:	DWG NUMBER:	ORIGINAL SIZE:	
S: LEVEL 1, CHAPEL RD. BANKSTOWN.	BASEMENT & POOL	22808	A09	A3	-
0 5556 M: 0422 606 228 am@nemcodesign.com.au	50 CHASELING ST, GREENACRE LOT 75, DP 35156	DESIGNED BY: A.N.	DATE: 03.02.2023		ŝ
angrencouragneonau		A.N.	03.02.2023		3
	3D_FIRST FLOOR	DRAWN BY:	SCALE:	F	-
		A.N.	AS SHOWN	\square	1

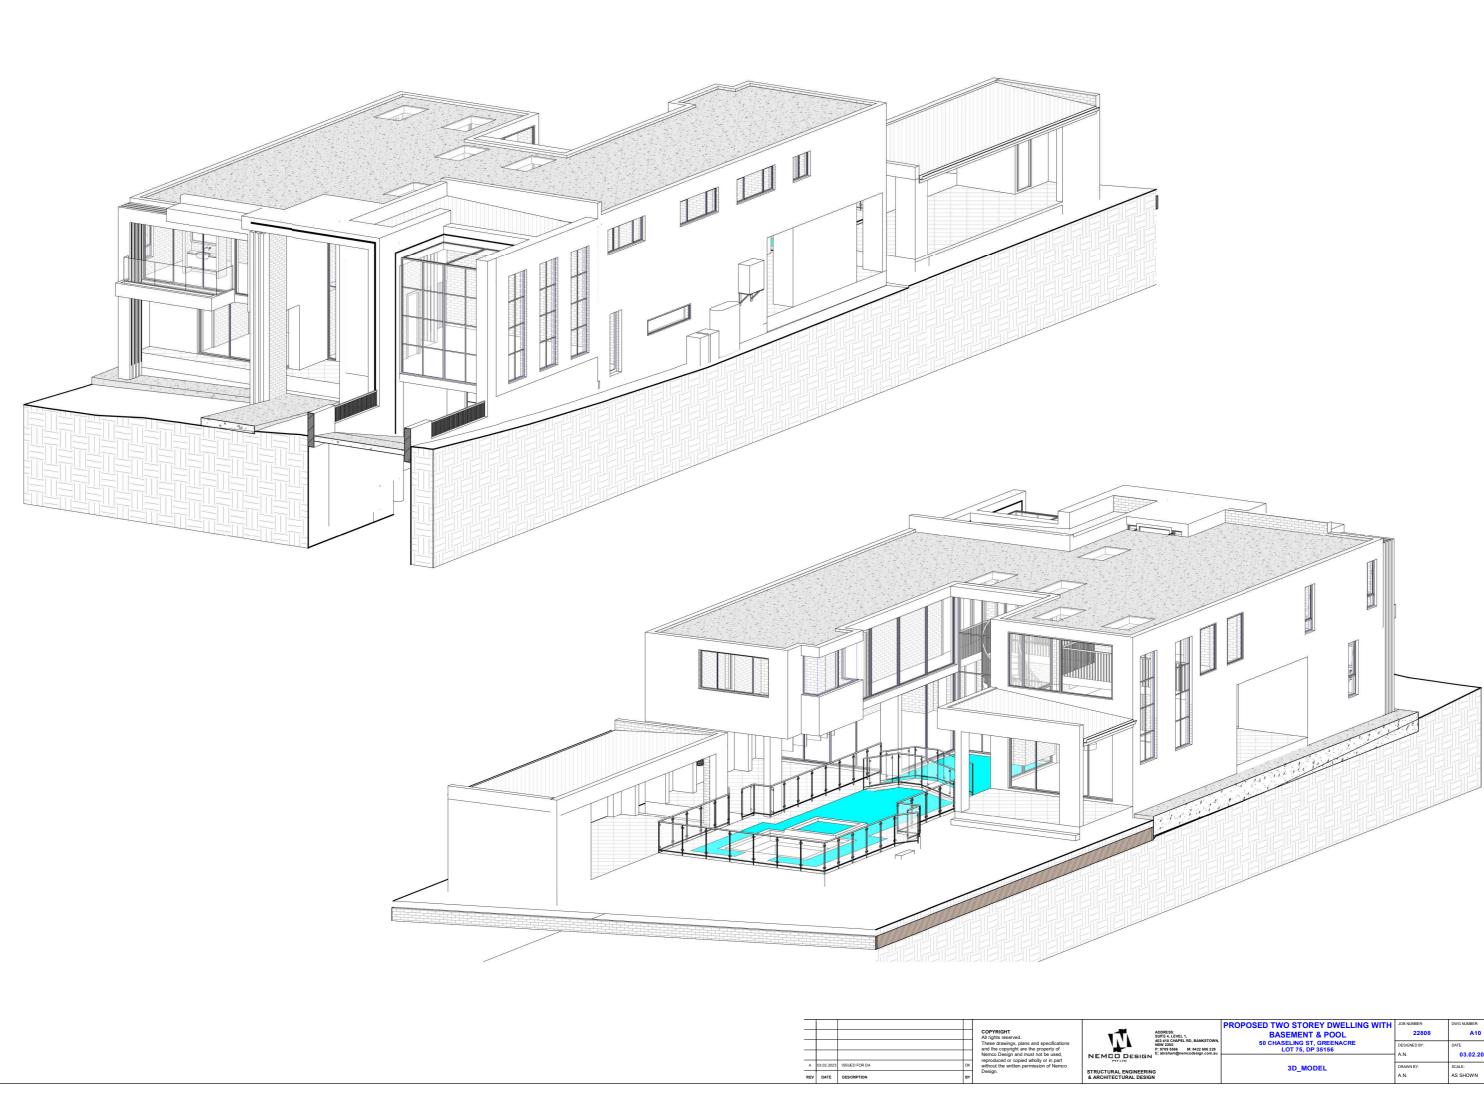

	PROPOSED TWO STOREY DWELLING WITH	JOB NUMBER:	DWG NUMBER:	ORIGINAL SIZE:	
S: LEVEL 1.	BASEMENT & POOL	22808	A10	A3	
CHAPEL RD, BANKSTOWN, 00 5556 M: 0422 606 228 am@nemcodesion.com.au	50 CHASELING ST, GREENACRE LOT 75, DP 35156	DESIGNED BY: A.N.	DATE: 03.02.2023		
		A.N.	03.02.2023		
	3D_MODEL	DRAWN BY: A.N.	SCALE: AS SHOWN	ED	





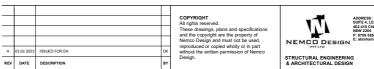



SS: I, LEVEL 1, J, CHAPEL RD, BANKSTOWN	PROPOSED TWO STOREY DWELLING WITH BASEMENT & POOL	JOB NUMBER: 22808	DWG NUMBER: A11	ORIGINAL SIZE: A3
200 5556 M: 0422 606 228 ham@nemcodesign.com.au	50 CHASELING ST, GREENACRE LOT 75, DP 35156	DESIGNED BY: A.N.	DATE: 03.02.2023	A
	3D_MODEL	DRAWN BY: A.N.	SCALE: AS SHOWN	D

<i>l</i> ark	Height	Width	Area	Level
W1	6000	435	2.61 m ²	HGF1
W2	6000	435	2.61 m ²	HGF1
W3	4450	500	2.23 m ²	HGF1
W3	4450	1885	8.39 m ²	HGF2
W5	4450	1885	8.39 m ²	HGF2
W6	4450	1250	5.19 m ²	HGF2
W7	4150	1250	5.19 m ²	HGF2
W8	4150	1250	5.19 m ²	HGF2
W9	600	3000	1.80 m ²	GF
W10	3000	2115	6.35 m ²	GF
W10	3000	2115	6.35 m ²	GF
W12	6000	2000	12.00 m ²	GF
W12	6000	2000	12.00 m ²	GF
W14	2400	1000	2.40 m ²	GF
W15	2400	1000	2.40 m ²	GF
W16	600	2115	1.27 m ²	GF
W17	600	2115	1.27 m ²	GF
W18	4150	1250	5.19 m ²	FF
W19	4150	1250	5.19 m ²	FF
W20	2100	1810	3.80 m ²	GF
W21	2100	730	1.53 m ²	HGF1
W22	2400	1200	2.88 m ²	FF
W23	970	2650	2.57 m ²	FF
W24	970	2650	2.57 m ²	FF
W25	970	2650	2.57 m ²	FF
W26	970	1210	1.17 m ²	FF
W27	1500	640	0.96 m ²	FF
W28	1500	1520	2.28 m ²	FF
W29	1500	1520	2.28 m ²	FF
W30	1500	640	0.96 m ²	FF
W31	2700	2115	5.71 m ²	FF
W32	2700	2115	5.71 m ²	FF
W33	2700	2115	5.71 m ²	FF
W34	2700	2115	5.71 m ²	FF
W35	3000	2115	6.35 m ²	FF
W36	3000	2115	6.35 m ²	FF
W37	2100	2250	4.73 m ²	FF
W38	2100	2250	4.73 m ²	FF
W39	1800	1210	2.18 m ²	FF
W40	1800	1210	2.18 m ²	FF
W41	1500	3000	4.50 m ²	FF
W42	1800	730	1.31 m ²	FF
W43	1800	730	1.31 m ²	FF

GLASS DOORS SCHEDULE - DWELLING					
Mark	Height	Width	Area	Level	
SD1	2510	4050	10.17 m ²	HGF1	
SD2	3000	4495	13.49 m ²	GF	
SD3	3000	4495	13.49 m ²	GF	
SD4	2400	3960	9.50 m ²	FF	
Grand to	Grand total: 4		46.64 m ²		


				COPYRIGHT All rights reserved. These drawings, plans and specifications and the copyright are the property of Nemco Design and must not be used,		ADDRESS: SUITE 4, LEVEL 402-410 CHAPEL NSW 2200 P: 9709 5556 E: abraham@nei
A	03.02.2023	ISSUED FOR DA	DK	reproduced or copied wholly or in part without the written permission of Nemco	PTYLTD	
REV	DATE	DESCRIPTION	BY	Design.	STRUCTURAL ENGINEERIN & ARCHITECTURAL DESIG	

S: LEVEL 1, CHAPEL RD. BANKSTOWN.	BASEMENT & POOL	JOB NUMBER: 22808	DWG NUMBER: A12	ORIGINAL SIZE: A3
0 556 M: 0422 606 228 mBnemcodesign.com.au	50 CHASELING ST, GREENACRE LOT 75, DP 35156	DESIGNED BY: A.N.	DATE: 03.02.2023	\mathcal{D}
•	WINDOWS & DOORS SCHEDULE	DRAWN BY:	03.02.2023 SCALE:	(\rightarrow)
		A.N.	AS SHOWN	ヘノ







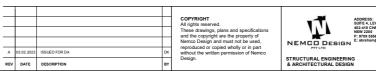




08: COLORBOND ROOF




10: FASCIA & GUTTER


	PROPOSED TWO STOREY DWELLING WITH	JOB NUMBER:	DWG NUMBER:	ORIGINAL SIZE:	
IS: LEVEL 1, CHAPEL RD. BANKSTOWN	BASEMENT & POOL	22808	A13	A3	
00 5556 M: 0422 606 228 am©nemcodesion.com.au	50 CHASELING ST, GREENACRE LOT 75, DP 35156	DESIGNED BY:	DATE: 03.02.2023	\mathcal{I}	
		A.N.	03.02.2023		
	SCHEDULE OF MATERIALS& FINISHES	DRAWN BY:	SCALE:		
		A.N.	AS SHOWN		

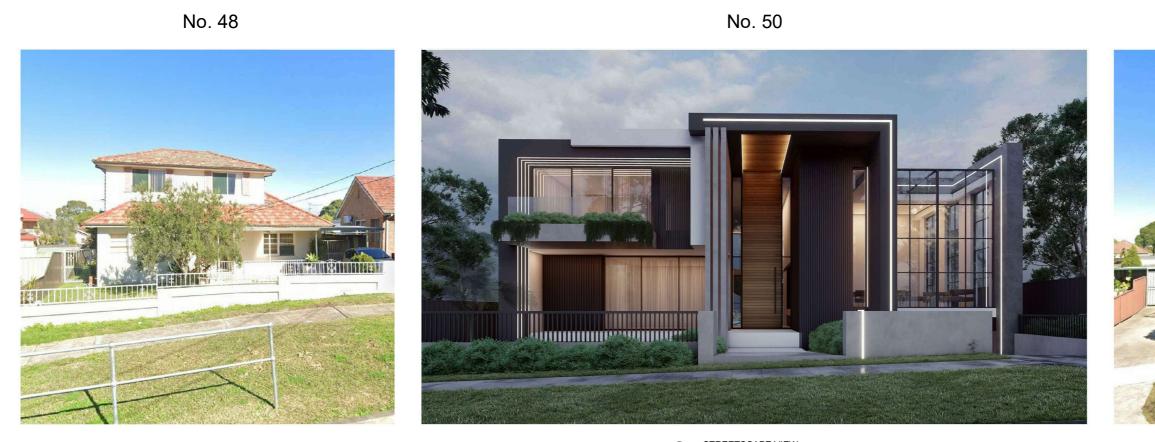

1 STREETSCAPE VIEW

CHASELING STREET

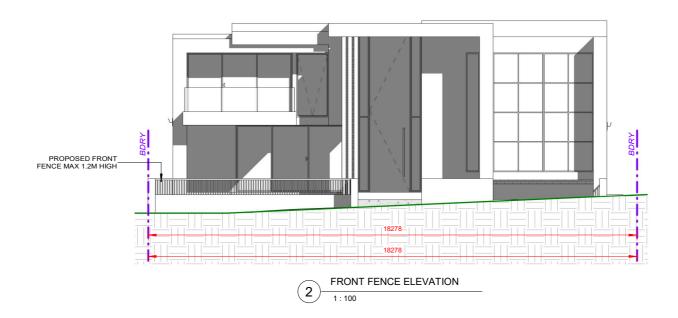


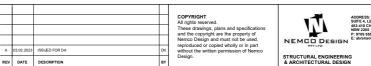







ESS:	PROPOSED TWO STOREY DWELLING WITH BASEMENT & POOL	JOB NUMBER: 22808	DWG NUMBER: A14	ORIGINAL SIZE: A3	9:17
4, LEVEL 1, 10 CHAPEL RD, BANKSTOWN, 2200 19 5556 M: 0422 606 228 aham®nemcodesign.com.au	50 CHASELING ST, GREENACRE LOT 75, DP 35156	DESIGNED BY:	DATE: 03.02.2023	\frown	3 2:4
	STREETSCAPE VIEW & FRONT FENCE ELEVATION	A.N.	SCALE: AS SHOWN	(\mathcal{P})	3/02/202

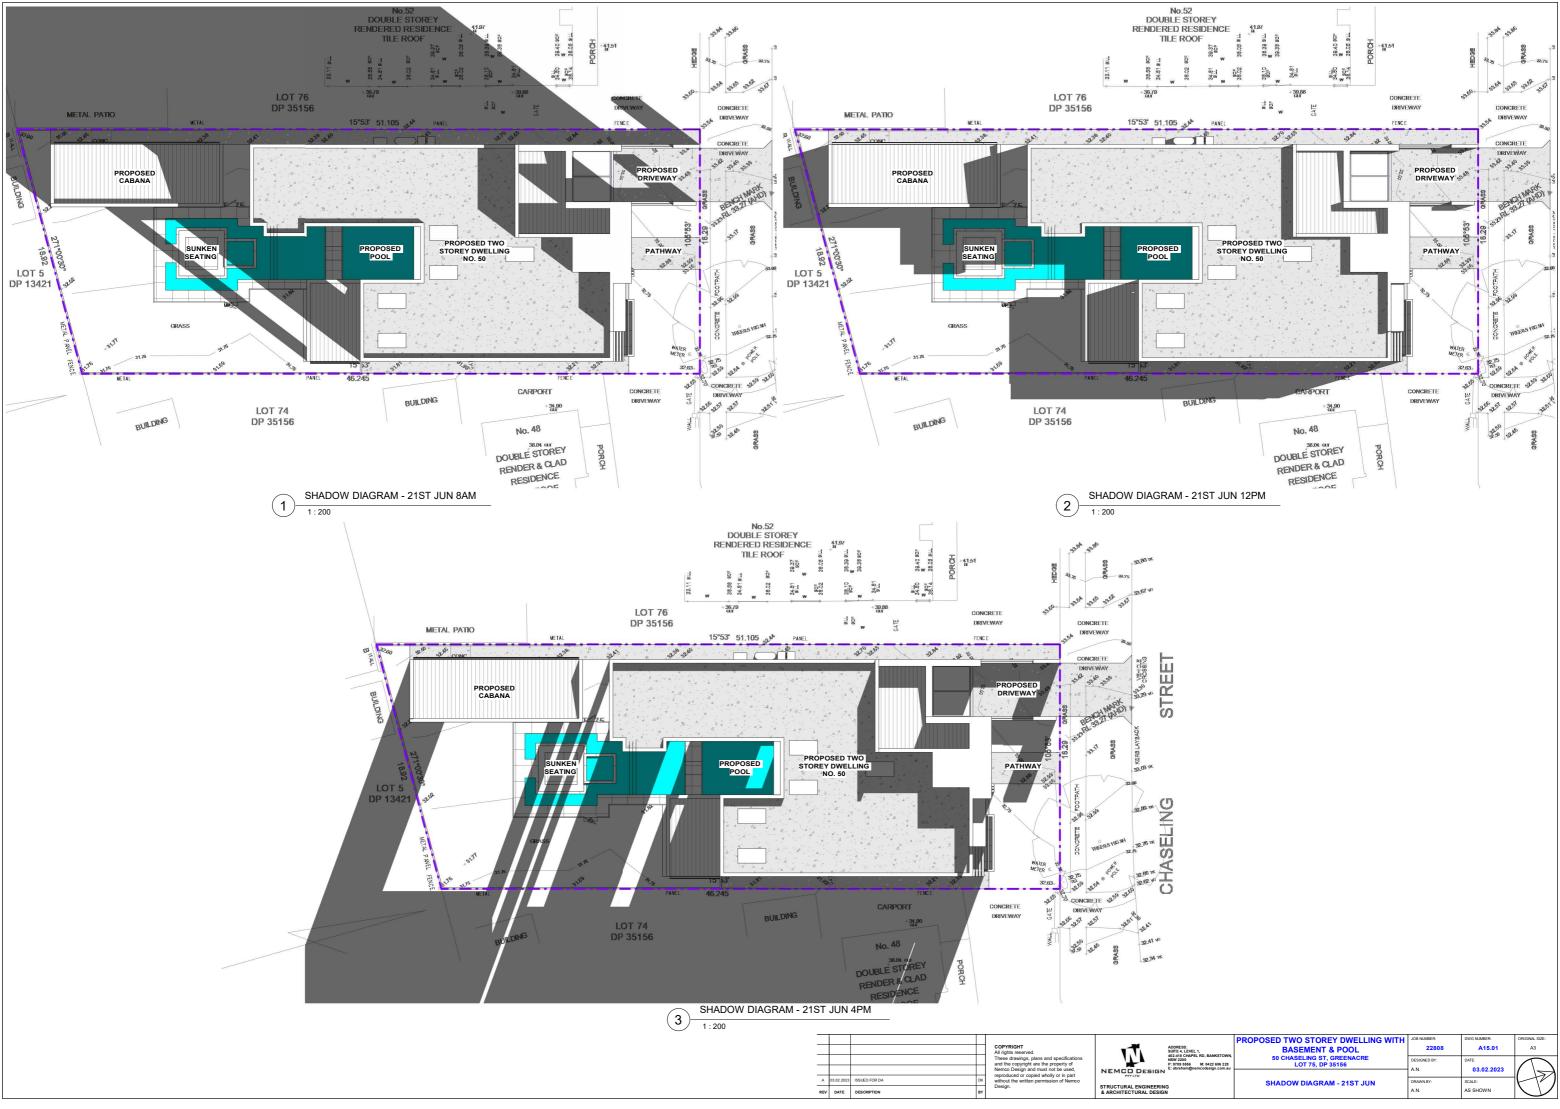

	PROPOSED TWO STOREY DWELLING WITH	JOB NUMBER:	DWG NUMBER:	ORIGINAL SIZE:
: EVEL 1, HAPEL RD. BANKSTOWN.	BASEMENT & POOL	22808	A15.01	A3
556 M: 0422 606 228	50 CHASELING ST, GREENACRE LOT 75, DP 35156	DESIGNED BY:	DATE: 03.02.2023	
		A.N.	03.02.2023	
	SHADOW DIAGRAM - 21ST JUN	DRAWN BY:	SCALE:	
		A.N.	AS SHOWN	$\wedge \vee$

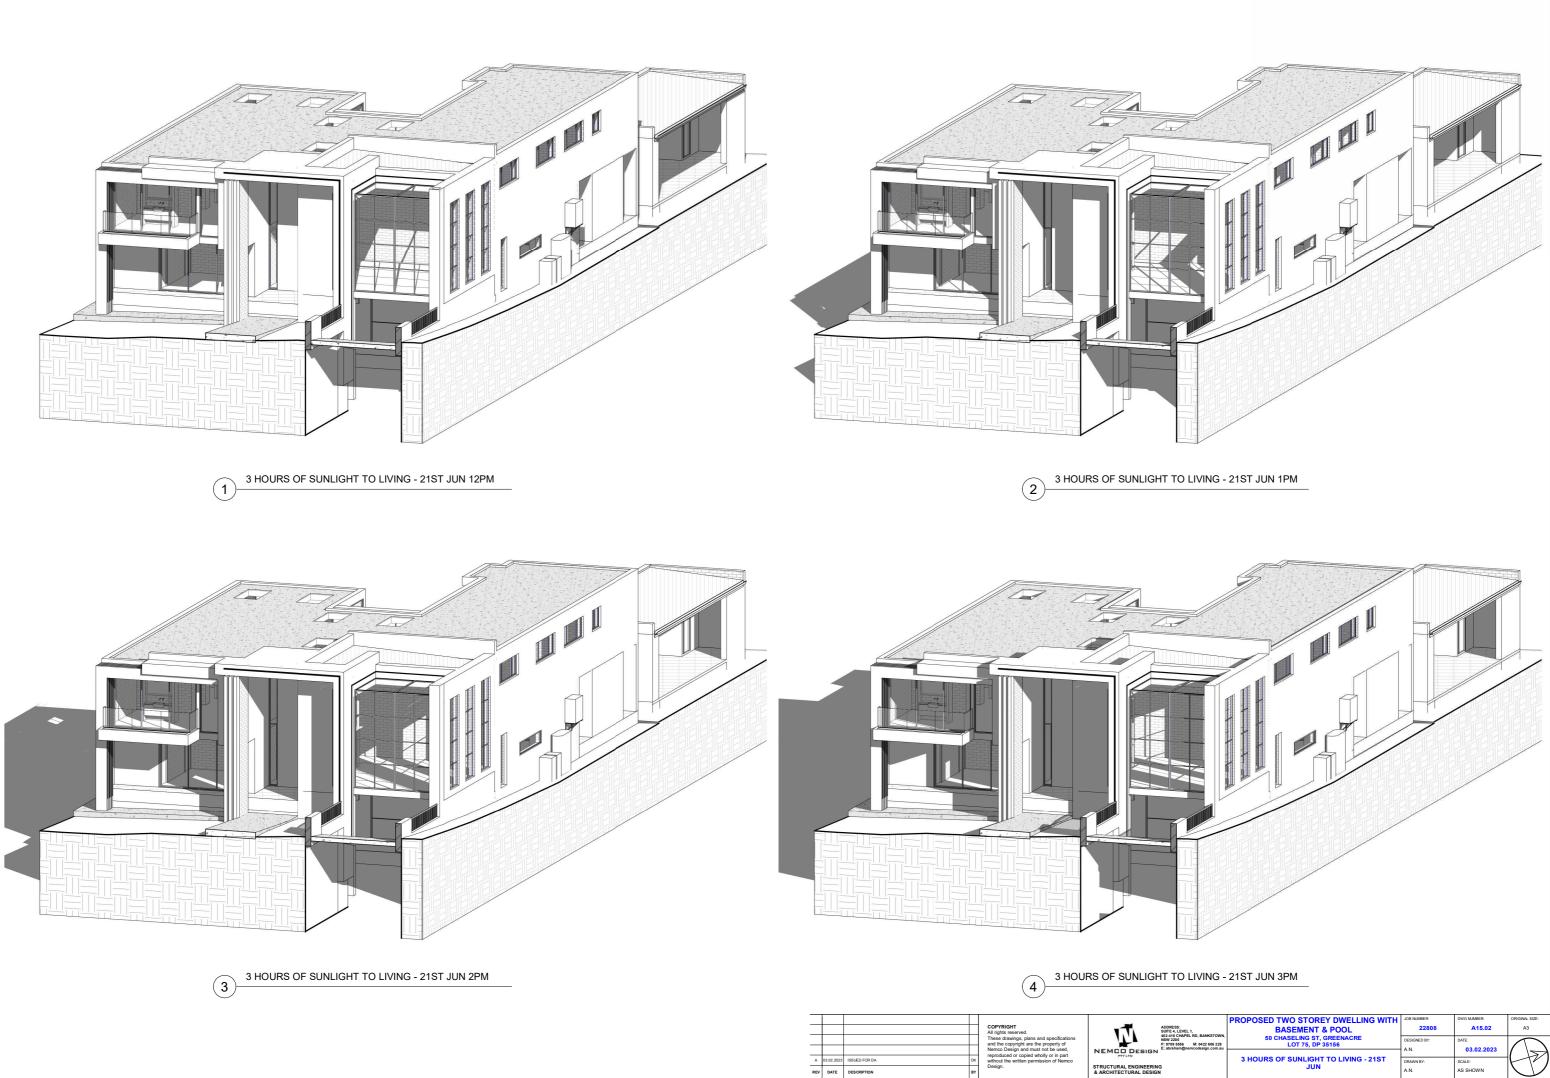

	PROPOSED TWO STOREY DWELLING WITH	JOB NUMBER:	DWG NUMBER:	ORIGINAL SIZE:	1
IS: LEVEL 1, CHAPEL RD. BANKSTOWN.	BASEMENT & POOL	22808	A15.02	A3	
00 5556 M: 0422 606 228 am©nemcodesign.com.au	50 CHASELING ST, GREENACRE LOT 75, DP 35156	DESIGNED BY:	DATE: 03.02.2023	\mathcal{I}	
anighten code sign contau		A.N.	03.02.2023		
	3 HOURS OF SUNLIGHT TO LIVING - 21ST JUN	DRAWN BY:	SCALE:		
	JUN	A.N.	AS SHOWN	ヘフ	

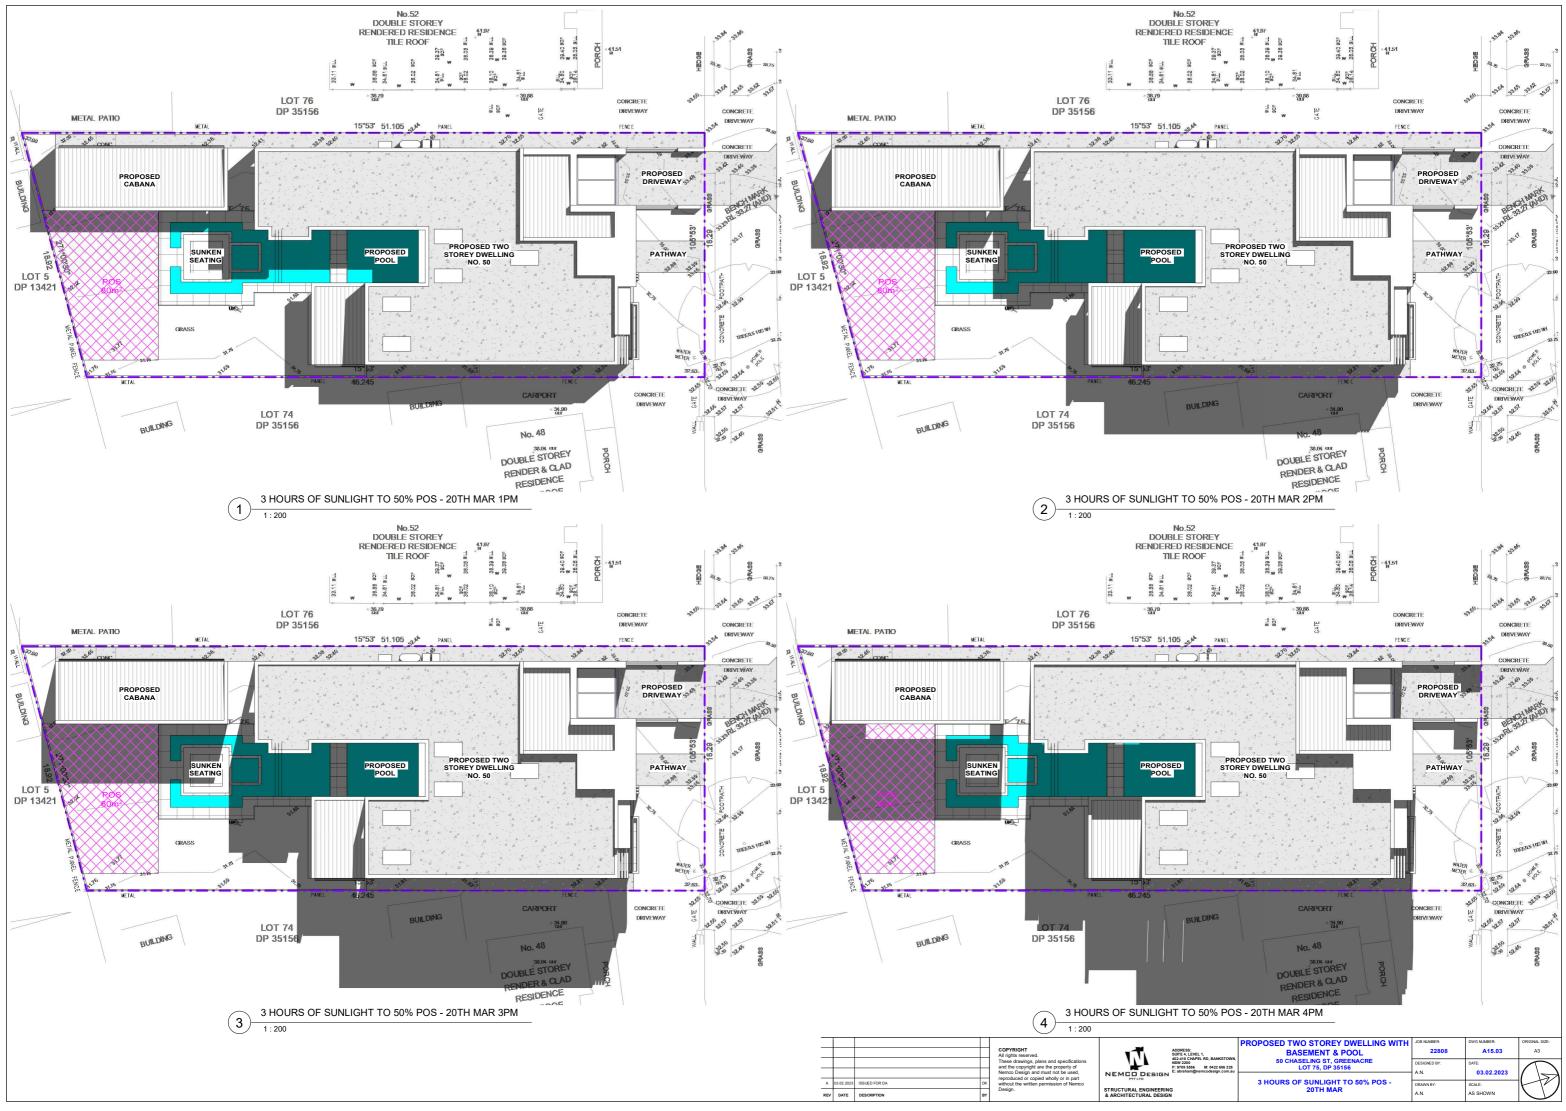

02/2023 2:49:24 PM

BASIX[°]Certificate

Building Sustainability Index www.basix.nsw.gov.au

Single Dwelling

Certificate number: 1367246S

This certificate confirms that the proposed development will meet the NSW government's requirements for sustainability, if it is built in accordance with the commitments set ou below. Terms used in this certificate, or in the commitments have the meaning given by the document entitled "BASIX Definitions" dated 1009/2020 published by the Department. This document is available at www.basik.nsw.gov.au

Secretary Date of issue: Tuesday, 24 January 2023 To be valid, this certificate must be lodged within 3 months of the date of issue.



	Project summary		
	Project name	50 Chaseling St, Gr	reenacre
	Street address	50 Chaseling Stree	t Greenacre 2190
	Local Government Area	Canterbury-Banksto	own Council
	Plan type and plan number	deposited 35156	
	Lot no.	75	
	Section no.	-	
	Project type	separate dwelling h	ouse
s.	No. of bedrooms	6	
	Project score		
	Water	✔ 40	Target 40
	Thermal Comfort	V Pass	Target Pass
	Energy	✓ 50	Target 50

page 1/9

page 4/9

Certificate Prepared by Name / Company Name: Nemco Design ABN (if applicable): 46166160505

	1. 61			6
Des	cription	i or pr	ojeci	0

Project name	50 Chaseling St, Greenacre	Assessor number	n/a	
Street address	50 Chaseling Street Greenacre 2190	Certificate number	n/a	
Local Government Area	Canterbury-Bankstown Council	Climate zone	n/a	
Plan type and plan number	Deposited Plan 35156	Area adjusted cooling load (MJ/m ² .year)	n/a	
Lot no.	75	Area adjusted heating load (MJ/m ² .year)	n/a	
Section no.		Ceiling fan in at least one bedroom	n/a	
Project type		Ceiling fan in at least one living room or	n/a	
Project type	separate dwelling house	other conditioned area	_	
No. of bedrooms	6	Project score		
Site details		Water	✓ 40	Target 40
Site area (m²)	890	Thermal Comfort	Pass	Target Pa
Roof area (m ²)	421		1 033	TargetTi
Conditioned floor area (m2)	299.9	Energy	50	Target 50
Unconditioned floor area (m2)	18.48			
Total area of garden and lawn (m2)	100			

Schedule of BASIX commitments The commitments set out below regulate how the proposed development is to be carrie development certificate issued, for the proposed development, that BASIX commitment

BAS

SD4

W22

W21 W39 W40 W41 W42 W43

SD3

SD5

South facing W37 W38 SD2

East facing

ater Commitments	Show on DA plans	Show on CC/CDC plans & specs	Certifie check
xtures			
e applicant must install showerheads with a minimum rating of 4 star (> 4.5 but <= 6 L/min plus spray force and/or coverage tests) in showers in the development.	1	~	~
applicant must install a toilet flushing system with a minimum rating of 6 star in each toilet in the development.		~	~
applicant must install taps with a minimum rating of 6 star in the kitchen in the development.		~	
applicant must install basin taps with a minimum rating of 6 star in each bathroom in the development.		~	
ternative water			
nwater tank			
e applicant must install a rainwater tank of at least 3000 litres on the site. This rainwater tank must meet, and be installed in ordance with, the requirements of all applicable regulatory authorities.	~	~	~
e applicant must configure the rainwater tank to collect rain runoff from at least 375.6 square metres of the roof area of the relopment (excluding the area of the roof which drains to any stormwater tank or private dam).		~	~
applicant must connect the rainwater tank to:			
all toilets in the development		~	~
at least one outdoor tap in the development (Note: NSW Health does not recommend that rainwater be used for human consumption in areas with potable water supply.)		~	~
vimming pool			
swimming pool must not have a volume greater than 100 kilolitres.	~	~	
swimming pool must have a pool cover.		~	
swimming pool must be outdoors.	~	~	

Water Commitments	Show on DA plans	Show on CC/CDC plans & specs	Certifier check
Fixtures			
The applicant must install showerheads with a minimum rating of 4 star (> 4.5 but <= 6 L/min plus spray force and/or coverage tests) in all showers in the development.		~	~
The applicant must install a toilet flushing system with a minimum rating of 6 star in each toilet in the development.		~	~
The applicant must install taps with a minimum rating of 6 star in the kitchen in the development.		~	
The applicant must install basin taps with a minimum rating of 6 star in each bathroom in the development.		~	
Alternative water			
Rainwater tank			
The applicant must install a rainwater tank of at least 3000 litres on the site. This rainwater tank must meet, and be installed in accordance with, the requirements of all applicable regulatory authorities.	~	~	~
The applicant must configure the rainwater tank to collect rain runoff from at least 375.6 square metres of the roof area of the development (excluding the area of the roof which drains to any stormwater tank or private dam).		~	~
The applicant must connect the rainwater tank to:			
all toilets in the development		~	~
 at least one outdoor tap in the development (Note: NSW Health does not recommend that rainwater be used for human consumption in areas with potable water supply.) 		~	~
Swimming pool			
The swimming pool must not have a volume greater than 100 kilolitres.	~	~	
The swimming pool must have a pool cover.		~	
The swimming pool must be outdoors.	~	~	

Thermal Comfort Commitments		Show on DA plans	Show on CC/CDC plans & specs	Certifier check
General features				
The dwelling must not have more than 2 storeys.		~		
The conditioned floor area of the dwelling must not exceed	200 square metres	×.	•	•
The conditioned hoor area of the dwelling must not exceed	500 square menes.	 	~	~
The dwelling must not contain open mezzanine area excee	ding 25 square metres.	~	~	~
The dwelling must not contain third level habitable attic root	m		~	~
Floor, walls and ceiling/roof				
the second se	/roof of the dwelling in accordance with the specifications listed in the ta	blo		
below.	roor or the dwelling in accordance with the specifications listed in the ta	V	~	~
Construction	Additional insulation required (R-Value) Ot	ner specifications		
Construction loor - concrete slab on ground, 218.7 square metres	Additional insulation required (R-Value) Oti nil	ner specifications		
		er specifications		
loor - concrete slab on ground, 218.7 square metres loor - above habitable rooms or mezzanine, 81.19 square	nil	ner specifications		
loor - concrete slab on ground, 218.7 square metres loor - above habitable rooms or mezzanine, 81.19 square metres, concrete	nil	ner specifications		
loor - concrete slab on ground, 218.7 square metres loor - above habitable rooms or mezzanine, 81.19 square metres, concrete loor - suspended floor above garage, concrete	nil nil nil	er specifications		

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mennal connort co	ommitments				Show on DA plans	Show on CC/CDC plans & specs	Certifier check
Windows, glazed do	ors and skyligh	nts					
			evices described in the table belo ons must be satisfied for each wir		~	~	~
The dwelling may have 1 s	skylight (<0.7 square	e metres) which is not I	listed in the table.		~	~	~
			window and glazed door: e performed by visual inspection.		~	~	~
- Aluminium single d							
- Aluminium double (
- Timber/uPVC/fibre	the second s						
- Timber/uPVC/fibre	glass double (air) cle		or glazed door beside which they	are situated when fully drawn or		~	
Timber/uPVC/fibre Vertical external louvre closed.	glass double (air) cle is and blinds must fu gs/vegetation must	ally shade the window be of the height and di	or glazed door beside which they istance from the centre and the b		5	č	* *
Timber/uPVC/fibre Vertical external louvre closed. Overshadowing buildin	glass double (air) cle is and blinds must fu gs/vegetation must	ally shade the window be of the height and di			v sion within	Overshadowing	č
Timber/uPVC/fibre Vertical external louvre closed. Overshadowing buildin door, as specified in t	glass double (air) cle is and blinds must fu gs/vegetation must the 'overshadowing'	ully shade the window be of the height and di column.	istance from the centre and the b	ase of the window and glazed Shading Device (Dimens	sion within	Overshadowing	ť
Timber/uPVC/fibre; Vertical external lowre closed. Overshadowing buildin door, as specified in 1 Window/glazed door no.	glass double (air) cle is and blinds must fu gs/vegetation must the 'overshadowing'	ully shade the window be of the height and di column.	istance from the centre and the b	ase of the window and glazed Shading Device (Dimens		Overshadowing	č
Timber/uPVC/fibre; Vertical external lowrer closed. Overshadowing buildin door, as specified in t Window/glazed door no. North facing	alass double (air) cle is and blinds must for gs/vegetation must the 'overshadowing' Maximum height (mm)	ully shade the window be of the height and di column. Maximum width (mm)	Type	ase of the window and glazed Shading Device (Dimens 10%) eave 3000 mm, 100 mm a	bove head		Ĵ
Timber/uPVC/fibre; Vertical external louve closed. Overshadowing buildin door, as specified in 1 Window/glazed door no. North facing W1	plass double (air) cle es and blinds must fu gs/vegetation must the 'overshadowing' Maximum height (mm) 6000	Illy shade the window i be of the height and di column. Maximum width (mm) 435	Type aluminium, single, clear	ase of the window and glazed Shading Device (Diment 10%) eave 3000 mm, 100 mm favindow or glazed door eave 3000 mm, 100 mm	bove head	>4 m high, <2 m away	č

aluminium, single 2650 aluminium, single 2650 aluminium, single 2650 aluminium, single 2650 aluminium, single 2110 aluminium, single
2650 aluminium, single 2650 aluminium, single 2650 aluminium, single 2650 aluminium, single
2650 aluminium, single 2650 aluminium, single
2650 aluminium, single
1210 aluminium, single
rsw.gov.au Version: 3.0 / DARWIN

or no. Maximum Maximum width Type height (mm) (mm)

3960

1200

1810

2250 2250 4495

4495

3600

240

2400

2100

2100 2100 3000

3000

2400

Energy Commitments	Show on DA plans	Show on CC/CDC plans & specs	Certifier check
Hot water			
The applicant must install the following hot water system in the development, or a system with a higher energy rating: electric heat pump with a performance of more than 45 STCs.	~	~	~
Cooling system			
The applicant must install the following cooling system, or a system with a higher energy rating, in at least 1 living area: 1-phase airconditioning; Energy rating: 6 Star (old label)		~	~
The applicant must install the following cooling system, or a system with a higher energy rating, in at least 1 bedroom: 1-phase airconditioning; Energy rating: 6 Star (old label)		~	~
Heating system			
The applicant must install the following heating system, or a system with a higher energy rating, in at least 1 living area: 1-phase airconditioning; Energy rating: 6 Star (old label)		~	~
The applicant must install the following heating system, or a system with a higher energy rating, in at least 1 bedroom: 1-phase airconditioning; Energy rating: 6 Star (old label)		~	~
Ventilation			
The applicant must install the following exhaust systems in the development:			
At least 1 Bathroom: individual fan, ducted to façade or roof; Operation control: manual switch on/off		~	~
Kitchen: individual fan, not ducted; Operation control: manual switch on/off		~	~
Laundry: individual fan, ducted to façade or roof; Operation control: manual switch on/off		~	~
Artificial lighting			
The applicant must ensure that the "primary type of artificial lighting" is fluorescent or light emitting diode (LED) lighting in each of the following rooms, and where the word "dedicated" appears, the fittings for those lights must only be capable of accepting fluorescent or light emitting diode (LED) langs:			
at least 6 of the bedrooms / study; dedicated			
at least 2 of the living / dining rooms; dedicated		~	~
* at reast 2 of the living running running running, devicated		~	~
the kitchen; dedicated		~	~
Planning, Industry & Environment www.basix.nsw.gov.au Version: 3.0 / DARWINIA 3 20.0 Certificate No.: 1367246S	Tuesday, 24 J	lanuary 2023	

	DA plans	plans & specs	check
all bathrooms/toilets; dedicated		~	
the laundry; dedicated			
all hallways; dedicated			
		~	
Natural lighting			
The applicant must install a window and/or skylight in the kitchen of the dwelling for natural lighting.	~	~	
The applicant must install a window and/or skylight in 4 bathroom(s)/toilet(s) in the development for natural lighting.	~	~	
Swimming pool			
The development must not incorporate any heating system for the swimming pool.		~	
The applicant must install a timer for the swimming pool pump in the development.		~	
Alternative energy			
The applicant must install a photovoltaic system with the capacity to generate at least 0.6 peak kilowatts of electricity as part of the sevelopment. The applicant must connect this system to the development's electrical system.	~		
The applicant must install a photovoltaic system with the capacity to generate at least 0.6 peak kilowatts of electricity as part of the levelopment. The applicant must connect this system to the development's electrical system. Other	~		
sevelopment. The applicant must connect this system to the development's electrical system.	~		
evelopment. The applicant must connect this system to the development's electrical system. Other	~	÷.	
development. The applicant must connect this system to the development's electrical system. Other The applicant must install a gas cooktop & electric oven in the kitchen of the develing. The applicant must construct each refrigerator space in the development so that it is "well ventilated", as defined in the BASIX			

Legend Legeno In these commitments, "applicant" means the person carrying out the development. Commitments identified with a win the "Show on DA plans" column must be shown on the plans accompanying the development application for the proport development application is to be lodged for the proposed development. Commitments identified with a win the "Show on COCD plans and spece" column must be shown in the plans and specifications accompanying the app certificate / compying development certificate for the proposed development.

	03.02.2023	ISSUED FOR DA	DK	COPYRIGHT All rights reserved. These drawings, plans and specifications and the copyright are the property of Nemco Design and must not be used, reproduced or copied wholly or in part without the writtine permission of Nemco	
REV	DATE	DESCRIPTION	BY	Design.	& ARCHITECTURAL DESIG



rried	out. It is	a condition	of any	development	consent	granted,	or complying	
ents	be comp	lied with.						

Туре	Shading Device (Dimension within 10%)	Overshadowing
aluminium, single, clear	eave 1200 mm, 325 mm above head of window or glazed door	2-4 m high, 2-5 m away
aluminium, single, clear	external louvre/vertical blind (fixed)	>4 m high, 5-8 m away
aluminium, single, clear	solid overhang 3000 mm, 600 mm above head of window or glazed door	2-4 m high, 2-5 m away
aluminium, single, clear	none	2-4 m high, 2-5 m away
aluminium, single, clear	none	>4 m high, 2-5 m away
aluminium, single, clear	none	2-4 m high, 2-5 m away
aluminium, single, clear	none	2-4 m high, 2-5 m away
aluminium, single, clear	none	2-4 m high, 2-5 m away
aluminium, single, clear	none	2-4 m high, 2-5 m away
aluminium, single, clear	none	>4 m high, <2 m away
aluminium, single, clear	none	>4 m high, 2-5 m away
aluminium, single, clear	verandah 9900 mm, 2975 mm above base of window or glazed door	2-4 m high, 2-5 m away
aluminium, single, clear	verandah 9900 mm, 2975 mm above base of window or glazed door	2-4 m high, 2-5 m away
aluminium, single, clear	eave 830 mm, 340 mm above head of window or glazed door	2-4 m high, 2-5 m away
aluminium, single, clear	none	>4 m high, 2-5 m away
aluminium, single, clear	none	>4 m high, <2 m away
aluminium, single, clear	none	>4 m high, <2 m away
aluminium, single, clear	none	>4 m high, 2-5 m away
aluminium, single, clear	none	>4 m high, 5-8 m away

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: EVEL 1, HAPEL RD. BANKSTOWN	PROPOSED TWO STOREY DWELLING WITH BASEMENT & POOL	JOB NUMBER: 22808	DWG NUMBER: A16	ORIGINAL SIZE: A3
MAPEL RD, BANKSTOWN, 556 M: 0422 606 228 m@nemcodesign.com.au	50 CHASELING ST, GREENACRE LOT 75, DP 35156	DESIGNED BY:	DATE: 03.02.2023	
	BASIX REQUIREMENTS	DRAWN BY: A.N.	SCALE: AS SHOWN	(P)